
TOWN OF MORIAH ESSEX COUNTY, NEW YORK

<u>SUPERVISOR</u> THOMAS R. SCOZZAFAVA

TOWN BOARD/COUNCILMEN
PAUL SALERNO
THOMAS ANDERSON
LUCI CARPENTER
MATTHEW BRASSARD

WATER AND SEWER DEPARTMENT
CARL (CHIP) PERRY
ARTHUR MORGAN

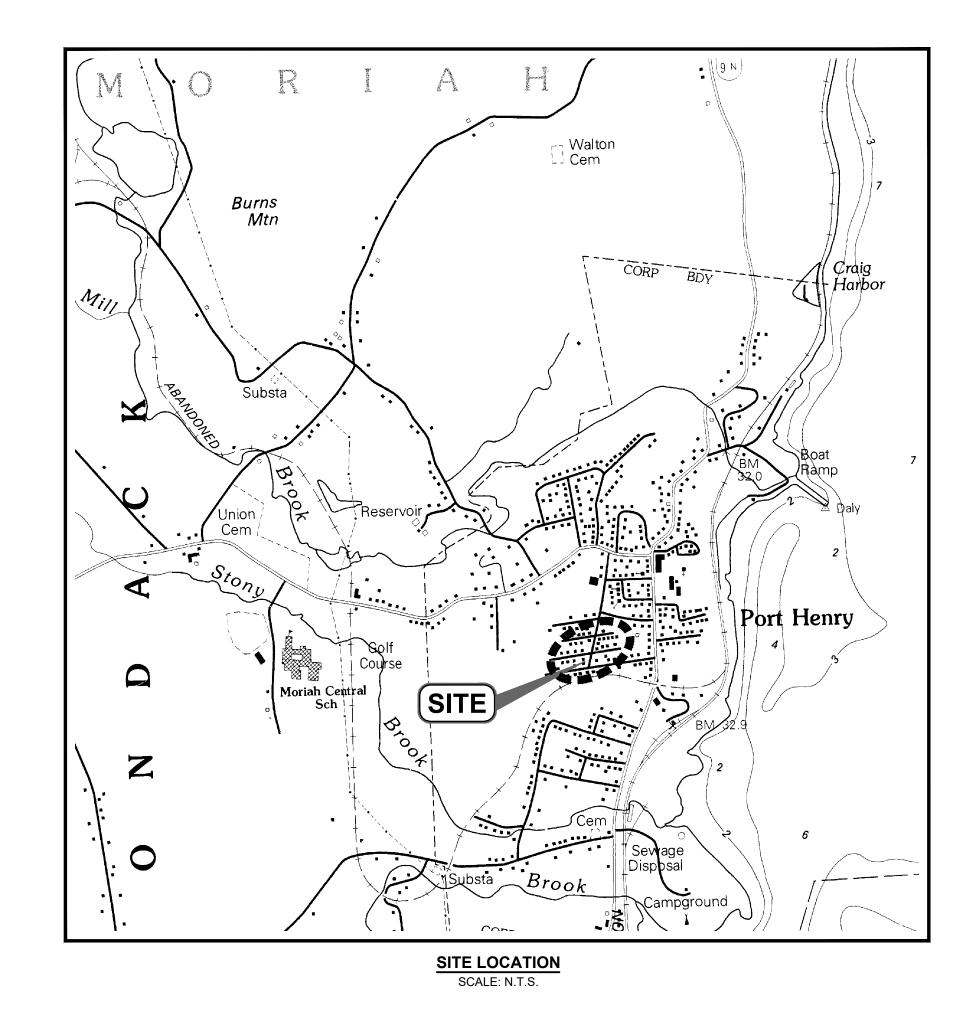

	DRAWING INDEX					
G-001	COVER SHEET AND DRAWING INDEX					
G-002	GENERAL NOTES, LEGEND, AND KEY PLAN					
C-100	EXISTING CONDITIONS PLAN: 1ST LANE TO ELIZABETH ST.					
C-101	EXISTING CONDITIONS AND REMOVALS PLAN: COLLEGE ST., RIDGE LANE, OAK LANE					
C-110	SITE RESTORATION PLAN: COLLEGE ST., RIDGE LANE, OAK LANE					
C-120	SANITARY SEWER LINING PLAN					
C-130	SANITARY SEWER PLAN AND PROFILE: RIDGE LANE					
C-131	SANITARY SEWER PLAN AND PROFILE: OAK LANE					
C-200	WATER MAIN PLAN & PROFILE: RIDGE LANE					
C-201	WATER MAIN PLAN & PROFILE: OAK LANE					
C-500	WATER DETAILS					
C-501	SANITARY SEWER DETAILS					
C-502	SITE DETAILS					

		SUBMITTAL / REVISIONS					TE OF NEW J	
No.	DATE	DESCRIPTION	BY	REVIEWED BY:	DATE	PROJ. MANAGER: CLD	S S S S S S S S S S S S S S S S S S S	
1	12/18/19	BID DOCUMENTS	MLB	C. DOOLEY		CHIEF DESIGNER: MLB		
						DESIGNED BY: MLB		
						DRAWN BY: MLB	125	
						CHECKED BY: CLD	Treels108	
							POFFERION A	
							TESSIO!	
							DATE	DATE

THE ALTERATION OF THIS MATERIAL IN ANY WAY, UNLESS DONE UNDER THE DIRECTION OF A COMPARABLE PROFESSIONAL, (I.E.) ARCHITECT FOR AN ARCHITECT, ENGINEER FOR AN ENGINEER OR LAND SURVEYOR FOR A LAND SURVEYOR, IS A VIOLATION OF THE NEW YORK STATE EDUCATION LAW AND/OR REGULATIONS AND IS A CLASS "A" MISDEMEANOR.



TOWN OF MORIAH

COVER SHEET AND DRAWING INDEX

WATER AND SEWER UPGRADES
ESSEX COUNTY NEW YORK

CONTRACT No.:MJ PROJ. No.: 1075.03
DATE: 12/18/19

G-001

SURVEY MAP NOTES

- INFORMATION SHOWN HEREON IS FROM A FIELD SURVEY CONDUCTED BY MJ ENGINEERING AND LAND SURVEYING, PC ON MAY 31, 2019 AND JUNE 4, 2019.
- 2. UNDERGROUND UTILITIES SHOWN HEREON ARE BASED ON SURFACE EVIDENCE AND INFORMATION RECORDED DURING CONVENTIONAL SURVEY METHODS. THIS MAPPING DOES NOT PURPORT TO SHOW ALL UNDERGROUND UTILITIES ON SITE AND IS SUBJECT TO FIELD VERIFICATION, REFER TO SPECIFICATION 023313.
- 3. THE HORIZONTAL DATUM IS REFERENCED TO NORTH AMERICAN DATUM OF 1983, NEW YORK STATE PLANE EAST ZONE 3101.
- 4. THE VERTICAL DATUM IS REFERENCED TO NORTH AMERICAN VERTICAL DATUM OF 1988
- 5. CONTOUR INTERVAL = 1 FOOT.
- 6. UNAUTHORIZED ALTERATIONS OR ADDITION TO THIS SURVEY MAP IS A VIOLATION OF SECTION 7209 OF THE NEW YORK STATE EDUCATION LAW. COPIES OF THIS SURVEY MAP NOT BEARING THE LAND SURVEYORS SEAL AND SIGNED WITH INK SHALL NOT BE CONSIDERED TO BE VALID COPIES.
- 7. PROPERTY LINES SHOWN ARE APPROXIMATE USING AVAILABLE SECTION MAPS AND TAX MAPS FROM ESSEX COUNTY DEPARTMENT OF ASSESSMENT, AND ARE SUBJECT TO VERIFICATION BY OTHERS
- 8. NORTH IS ORIENTED TO GRID NORTH FROM GPS OBSERVATION.

GENERAL NOTES:

- 1. THE CONTRACTOR SHALL VERIFY BOTH HORIZONTAL AND VERTICAL CONTROL INFORMATION PRIOR TO THE START OF CONSTRUCTION.
- 2. THE ENGINEER SHALL BE NOTIFIED IN WRITING OF ANY CONDITIONS THAT VARY FROM THOSE SHOWN ON THE PLANS. THE CONTRACTOR'S WORK SHALL NOT VARY FROM THE PLANS WITHOUT THE EXPRESSED APPROVAL OF THE ENGINEER.
- 3. THE CONTRACTOR SHALL BE RESPONSIBLE FOR OBTAINING AND INCURRING THE COST OF ALL REQUIRED PERMITS, INSPECTIONS, CERTIFICATES, ETC. AND SHALL COMPLY WITH ALL REQUIRED PERMITS
- 4. ALL WORK SHALL BE DONE IN STRICT COMPLIANCE WITH ALL APPLICABLE NATIONAL, STATE, AND LOCAL CODES, STANDARDS, ORDINANCES, RULES AND REGULATIONS.
- 5. THE ENGINEER RESERVES THE RIGHT TO EXAMINE ANY WORK DONE ON THIS PROJECT AT ANY TIME TO DETERMINE THE CONFORMANCE WITH THE REQUIREMENTS OF THE CONTRACT
- DOCUMENTS OF THIS PROJECT, AS INTENDED AND INTERPRETED BY THE ENGINEER.

 6. MISCELLANEOUS WORK NOT SPECIFICALLY SHOWN ON THE CONTRACT DRAWINGS SUCH AS PATCHING, BLOCKING, TRIMMING, ETC., SHALL BE PERFORMED AS REQUIRED TO COMPLETE
- 7. THE CONTRACTOR SHALL PROTECT EXISTING PROPERTY LINE MONUMENTATION. ANY MONUMENTATION DISTURBED OR DESTROYED, AS JUDGED BY THE ENGINEER OR OWNER, SHALL BE REPLACED AT THE CONTRACTOR'S EXPENSE UNDER THE SUPERVISION OF A NEW YORK STATE LICENSED LAND SURVEYOR.
- 8. THE CONTRACTOR SHALL BE RESPONSIBLE FOR PROVIDING ALL FIELD LAYOUT. THE CONTRACTOR SHALL TAKE TIES TO ALL UTILITY CONNECTIONS AND PROVIDE MARKED—UP RECORD DRAWINGS FOR ALL UTILITIES SHOWING TIES TO CONNECTIONS, BENDS, VALVES, LENGTHS OF LINES AND INVERTS. RECORD DRAWINGS SHOWING ALL UNDERGROUND UTILITIES INSTALLED OR ENCOUNTERED SHALL BE REVIEWED BY THE OWNER AND HIS REPRESENTATIVES. THE CONTRACTOR SHALL PROVIDE ANY CORRECTION OR ADMISSIONS TO THE SATISFACTION OF THE OWNER AND HIS REPRESENTATIVES BEFORE UTILITIES WILL BE ACCEPTED.
- 9. ALL TRENCH EXCAVATION AND ANY REQUIRED SHEETING AND SHORING SHALL BE DONE IN ACCORDANCE WITH THE LATEST REVISIONS OF NEW YORK STATE INDUSTRIAL CODE RULE 23 AND OSHA REGULATIONS FOR CONSTRUCTION. SHEET PILING SHALL BE DESIGNED AND SEALED BY A NEW YORK STATE PROFESSIONAL ENGINEER.
- 10. ALL OPEN TRENCHES, EXCAVATIONS OR HOLES SHALL BE PLATED AT THE END OF THE
- 11. CONTRACTOR SHALL BE RESPONSIBLE FOR DEWATERING AND THE MAINTENANCE OF SURFACE DRAINAGE DURING THE COURSE OF WORK AND SHALL SUBMIT A DEWATERING PLAN DESIGNED AND SEALED BY A NEW YORK STATE PROFESSIONAL ENGINEER. CONTRACTOR SHALL MAINTAIN EXISTING SITE DRAINAGE PATTERNS THROUGHOUT CONSTRUCTION UNLESS OTHERWISE SHOWN ON THE PLANS.
- 12. CONTRACTOR SHALL TAKE CARE TO PREVENT DAMAGE TO EXISTING UTILITIES. DAMAGED UTILITIES SHALL BE IMMEDIATELY REPAIRED BY THE CONTRACTOR'S
- 13. THE CONTRACTOR SHALL PROVIDE ALL NECESSARY EROSION CONTROL MEASURES IN ACCORDANCE WITH THE 'NEW YORK STATE STANDARDS AND SPECIFICATIONS FOR EROSION AND SEDIMENT CONTROL".
- 14. CHLORINATED WATER SHALL NOT BE DISCHARGED TO THE ENVIRONMENT WITHOUT FIRST DECHLORINATING IN ACCORDANCE WITH AWWA C651.
- 15. ALL UTILITY WORK INVOLVING CONNECTIONS TO THE EXISTING SYSTEMS SHALL BE COORDINATED WITH THE ENGINEER AND THE UTILITY OWNER. NOTIFY THE ENGINEER AND THE UTILITY OWNER 72 HOURS BEFORE EACH AND EVERY CONNECTION TO AN EXISTING
- 16. MAINTAIN FLOW FOR ALL EXISTING UTILITIES.
- 17. CONTRACTOR SHALL COORDINATE WITH UTILITY COMPANY FOR TEMPORARY POLE SUPPORT DURING CONSTRUCTION. CONTRACTOR IS RESPONSIBLE FOR ALL COSTS ASSOCIATED WITH TEMPORARY UTILITY SUPPORT.
- 18. ALL PROPOSED UTILITIES AND APPURTENANCES SHALL BE CONSTRUCTED IN COMPLIANCE WITH THE LOCAL MUNICIPALITIES' CODES AND REGULATIONS GOVERNING THE INSTALLATION OF SUCH UTILITIES.
- 19. UNDERGROUND UTILITIES SHOWN ARE APPROXIMATE ONLY IN LOCATION. CONTRACTOR SHALL CONTACT AND RETAIN AN UNDERGROUND UTILITY LOCATING SERVICE IN ACCORDANCE WITH SPECIFICATION 023313 TO LOCATE UTILITY LINES WITHIN THE WORK AREAS TO FACILITATE CONSTRUCTION WORK. DAMAGE TO UTILITIES RESULTING FROM NEGLIGENCE OR FAILURE TO MAKE ACCURATE UTILITY LOCATIONS IS THE RESPONSIBILITY OF THE CONTRACTOR. THE CONTRACTOR SHALL BE RESPONSIBLE FOR ANY DELAYS OR DAMAGES OCCURRING AS A RESULT OF INCORRECTLY LOCATED UTILITIES.

BY REVIEWED BY:

MLB | C. DOOLEY

DATE

PROJ. MANAGER: | CLI

DESIGNED BY:

CHECKED BY:

DRAWN BY:

CHIEF DESIGNER: MLE

OFESSIO'

RECONSTRUCTION NOTES:

- 1. THE CONTRACTOR'S ATTENTION IS DIRECTED TO THE FACT THAT, DUE TO THE NATURE OF RECONSTRUCTION PROJECTS, THE EXACT EXTENT OF RECONSTRUCTION WORK CANNOT ALWAYS BE ACCURATELY DETERMINED PRIOR TO THE COMMENCEMENT OF WORK. THESE CONTRACT DOCUMENTS HAVE BEEN PREPARED BASED ON FIELD INSPECTION AND OTHER INFORMATION AVAILABLE AT THE TIME OF DESIGN. ACTUAL FIELD CONDITIONS MAY REQUIRE MODIFICATIONS TO CONSTRUCTION DETAILS AND WORK QUANTITIES. THE CONTRACTOR SHALL PERFORM THE WORK IN ACCORDANCE WITH FIELD CONDITIONS.
- 2. THE CONTRACTOR SHALL EXERCISE CARE IN HIS REMOVAL OPERATIONS SO AS NOT TO UNDULY DISTURB UNDERLYING MATERIALS WHICH ARE TO REMAIN IN PLACE. THE CONTRACTOR SHALL PERFORM ALL WORK WITH CARE SO THAT ALL MATERIALS WHICH ARE TO REMAIN IN PLACE, OR WHICH ARE TO REMAIN THE PROPERTY OF THE TOWN, WILL NOT BE DAMAGED. IF THE CONTRACTOR DAMAGES ANY MATERIALS WHICH ARE TO REMAIN, THE DAMAGED MATERIALS SHALL BE REPAIRED OR REPLACED IN A MANNER SATISFACTORY TO THE ENGINEER AT NO ADDITIONAL EXPENSE TO THE OWNER.
- 3. DURING REMOVAL OPERATIONS, THE CONTRACTOR SHALL NOT BE ALLOWED TO DROP WASTE CONCRETE, DEBRIS OR OTHER MATERIAL IN THE SEWAGE AND/OR STORM SEWER COLLECTION SYSTEMS EXCEPT WHERE THE PLANS SPECIFICALLY PERMIT THE DROPPING OF MATERIAL. PLATFORMS, NETS, SCREENS OR OTHER PROTECTION DEVICES SHALL BE USED TO CATCH THE MATERIAL. IF THE ENGINEER DETERMINES THAT ADEQUATE PROTECTIVE DEVICES ARE NOT BEING EMPLOYED, THE WORK SHALL BE SUSPENDED UNTIL ADEQUATE PROTECTION IS PROVIDED.
- 4. THE CONTRACTOR SHALL RESTORE ROADS, LAWNS, DRIVEWAYS, GUARDRAILS, CULVERTS, CULVERT END SECTIONS, SIGNS AND OTHER PUBLIC OR PRIVATE PROPERTY DAMAGED OR REMOVED TO AT LEAST AS GOOD A CONDITION AS BEFORE BEING DISTURBED AS DETERMINED BY THE ENGINEER. ANY DAMAGED TREES, SHRUBS, AND/OR HEDGES SHALL BE REPLACED AT THE CONTRACTOR'S EXPENSE.
- 5. ALL EARTHWORK GRADING SHALL BE BLENDED SMOOTHLY AND EVENLY INTO EXISTING CONDITIONS

UNDERGROUND UTILITY NOTES:

- 1. CALL BEFORE YOU DIG:
- IF YOU PLAN TO DIG OR DO ANY TYPE OF EXCAVATION WORK, NEW YORK STATE LAW REQUIRES YOU CALL DIG SAFELY NEW YORK PRIOR TO DOING SO.
- 2. WAIT THE REQUIRED TIME: YOU NEED TO PROVIDE TWO FULL WORKING DAYS NOTICE PRIOR TO STARTING YOUR WORK, NOT COUNTING THE DAY OF YOUR CALL, WEEKENDS OR HOLIDAYS. THIS PROVIDES TIME FOR THE UTILITIES TO LOCATE YOUR PROPOSED DIG SITE.
- 3. CONFIRM UTILITY RESPONSE:

 DIG SAFELY NEW YORK WILL NOTIFY ALL MEMBER UTILITIES OF THE PENDING EXCAVATION
 SO THAT THAT THEY CAN COME OUT AND MARK THE LOCATION OF THEIR LINDERCROLLING.
- DIG SAFELY NEW YORK WILL NOTIFY ALL MEMBER UTILITIES OF THE PENDING EXCAVATION SO THAT THAT THEY CAN COME OUT AND MARK THE LOCATION OF THEIR UNDERGROUND LINES. BEFORE DIGGING ON YOUR STATED COMMENCEMENT DATE CONFIRM THAT ALL UTILITIES HAVE RESPONDED TO YOU INDICATING THEY HAVE MARKED YOUR PROPERTY OR THEY HAVE NO FACILITIES PRESENT.
- 4. RESPECT THE MARKS:

 BEFORE YOU BEGIN YOUR EXCAVATION, WALK THROUGH THE SITE TO FAMILIARIZE YOURSELF WITH THE MARKINGS AND THE LOCATIONS OF BURIED FACILITIES.
- IT IS IMPORTANT EXCAVATORS TAKE A PROACTIVE APPROACH TO SAFETY NOT ONLY FOR THEMSELVES BUT FOR THE PUBLIC BY INITIATING THE ONE CALL PROCESS AND ADHERING
- 6. IN ADDITION TO DIG SAFELY NEW YORK NOTIFICATION MEASURES, CONTRACTOR SHALL BE RESPONSIBLE FOR THIRD PARTY UTILITY DESIGNATION WITHIN THE ENTIRE PROJECT AREA. THIRD PARTY UTILITY DESIGNATION SHALL INCLUDE A QUALITY LEVEL B INVESTIGATION, IN ADDITION TO POTHOLING/TEST PITS AT LOCATIONS DIRECTED BY ENGINEER. POTHOLING/TEST PIT LOCATIONS INCLUDE, BUT ARE NOT LIMITED TO, PROPOSED CONNECTION POINTS TO THE EXISTING WATER MAIN, LOCATIONS OF EXISTING WATER SERVICE AND HYDRANT LATERAL CONNECTIONS, UTILITY CROSSINGS, AND LOCATIONS WHERE THE PROPOSED WATER MAIN IS WITHIN 5' OF EXISTING BURIED UTILITIES, AS IDENTIFIED DURING THE QUALITY LEVEL B INVESTIGATION. REFER TO SPECIFICATION SECTION 023313 FOR SUBSURFACE UTILITY DESIGNATION REQUIREMENTS.

WATER MAIN AND SERVICES INSTALLATION NOTES:

TO THE FIVE STEPS OF A SAFE EXCAVATION.

- 1. ALL NEW WATER MAIN PIPING SHALL BE CL52 DUCTILE IRON PIPE, UNLESS OTHERWISE NOTED.
- 2. ALL DUCTILE IRON FITTINGS, PIPING, VALVES AND APPURTENANCES SHALL BE WRAPPED WITH POLYETHYLENE ENCASEMENT. POLYETHYLENE ENCASEMENT ON EXISTING DUCTILE
- 3. CONTRACTOR SHALL COORDINATE ALL CONNECTIONS TO EXISTING WATER MAINS AND SERVICES WITH THE TOWN. CONTRACTOR SHALL NOTIFY TOWN NO LESS THAN ONE WEEK PRIOR TO TEMPORARY SHUTDOWN OF WATER MAINS AND SERVICES.

IRON WATER MAINS SHALL BE REPAIRED AFTER CONNECTION IS MADE.

- 4. WATER SERVICE LOCATIONS SHOWN ON THE DRAWINGS ARE FOR ESTIMATING PURPOSES ONLY. CONTRACTOR SHALL COORDINATE EXACT LOCATION WITH HOMEOWNER, ENGINEER AND TOWN.
- 5. EXISTING WATER SERVICES SHALL BE REPLACED AS FOLLOWS:
- A. EXISTING WATER SERVICES SHALL BE REPLACED FROM NEW WATER MAIN TO PROPERTY LINE. PROVIDE NEW 3/4" TYPE K COPPER SERVICE LINES EXTENDING FROM NEW WATER MAIN TO THE PROPERTY LINE. INSTALL NEW CURB STOPS AND CURB BOXES WITH STAINLESS STEEL RODS AT THE PROPERTY LINE. REMOVE AND DISPOSE OF EXISTING PIPING AND CURB BOX. IF EXISTING SERVICE IS DIFFERENT THAN 3/4", MATCH EXISTING SERVICE SIZE. IN LOCATIONS WHERE THE EXISTING CURB STOP IS BEYOND THE R.O.W., CONTRACTOR SHALL EXTEND NEW SERVICE FROM CURB STOP AT PROPERTY LINE TO CONNECT TO EXISTING SERVICE. PROVIDE NECESSARY
- COUPLINGS/ADAPTERS TO CONNECT TO EXISTING SERVICE.

 B. ADD ALTERNATE NO. 1: EXISTING LEAD OR GALVANIZED WATER SERVICES SHALL BE REPLACED FROM NEW CURB STOP TO HOUSE. PROVIDE NEW 3/4" TYPE K COPPER SERVICE LINES EXTENDING FROM NEW CURB STOP TO THE HOUSE. PROVIDE NECESSARY COUPLINGS/ADAPTERS TO CONNECT TO EXISTING SERVICE AT HOUSE. CONNECTION TO EXISTING WATER SERVICE SHALL BE MADE 2' OUTSIDE BUILDING FOUNDATION. NO WORK SHALL BE CONDUCTED INSIDE BUILDING.
- 6. ALL NEW WATER MAIN PIPING, INCLUDING SERVICE LINES, SHALL BE TESTED AND DISINFECTED IN ACCORDANCE WITH SECTION 330500.

DATE

7. CONTRACTOR SHALL REMOVE ALL VALVE BOXES THAT ARE ON WATER MAINS TO BE ABANDONED. CONTRACTOR SHALL RESTORE AREAS WHERE VALVE BOXES AND HYDRANTS WERE REMOVED TO PRE-EXISTING CONDITIONS.

SANITARY SEWER MAIN AND LATERALS INSTALLATION NOTES:

- 1. ALL NEW SANITARY SEWER MAIN SHALL BE SDR35 PVC, UNLESS OTHERWISE NOTED.
- 2. SANITARY SEWER LATERALS AND CLEANOUT LOCATIONS SHOWN ON THE DRAWINGS ARE APPROXIMATE AND FOR ESTIMATING PURPOSES ONLY. CONTRACTOR SHALL COORDINATE EXACT LOCATION WITH HOMEOWNER, ENGINEER AND TOWN. CONTRACTOR SHALL VERIFY SIZE AND DEPTH OF EXISTING SANITARY SEWER LATERALS PRIOR TO RECONNECTION.
- 3. CONDUCT EXPLORATORY TEST PITS AT ALL UTILITY CROSSINGS TO DETERMINE LOCATION AND DEPTH OF EXISTING UTILITIES. IN THE EVENT UTILITIES ARE NOT AT THE VERTICAL DEPTHS SHOWN, IMMEDIATELY NOTIFY THE ENGINEER FOR ADJUSTMENT OF THE PIPING VERTICAL ALIGNMENT.
- 4. CONTRACTOR SHALL COORDINATE LATERAL REPLACEMENT WITH TOWN AND ENGINEER. TOWN TO CCTV EXISTING LATERAL FROM CLEANOUT TO HOUSE PRIOR TO RECONNECTION.
- 5. EXISTING SANITARY SEWER LATERALS SHALL BE REPLACED AS FOLLOWS:
 A. EXISTING LATERALS SHALL BE REPLACED FROM NEW SANITARY SEWER MAIN TO PROPERTY LINE. PROVIDE NEW 4" SDR35 LATERALS EXTENDING FROM NEW SANITARY SEWER MAIN TO THE PROPERTY LINE. INSTALL NEW CLEANOUTS AT THE PROPERTY LINE. REMOVE AND DISPOSE OF EXISTING PIPING AND CLEANOUT. IN LOCATIONS WHERE THE EXISTING CLEANOUT IS BEYOND THE R.O.W., CONTRACTOR SHALL EXTEND NEW LATERAL FROM CLEANOUT AT PROPERTY LINE TO CONNECT TO EXISTING LATERAL.
- PROVIDE NECESSARY COUPLINGS/ADAPTERS TO CONNECT TO EXISTING LATERAL.

 B. ADD ALTERNATE NO. 1: EXISTING SEWER LATERALS SHALL BE REPLACED FROM NEW CLEANOUT TO HOUSE. PROVIDE 4" SDR35 EXTENDING FROM NEW CLEANOUT TO THE HOUSE. PROVIDE NECESSARY COUPLINGS/ADAPTERS TO CONNECT TO EXISTING LATERAL AT HOUSE. CONNECTION TO EXISTING LATERAL SHALL BE MADE 2' OUTSIDE BUILDING FOUNDATION. NO WORK SHALL BE CONDUCTED INSIDE BUILDING.

MATERIAL STOCKPILE NOTES:

- 1. EXISTING EXCESS TOPSOIL SHALL BE REMOVED AND STORED IN STOCKPILES. THE STOCKPILES SHALL BE SUFFICIENTLY REMOVED FROM ALL OTHER EXCAVATION AND/OR DISTURBANCE AREAS TO AVOID MIXING. EXACT LOCATION OF ALL STOCKPILES SHALL BE COORDINATED WITH THE TOWN. SILT FENCE IS TO BE INSTALLED AROUND TOPSOIL STOCKPILE AREAS.
- 2. EXCESS SOIL TO BE STOCKPILED AS DESIGNATED BY THE TOWN (IF IT IS NOT USED IMMEDIATELY FOR GRADING PURPOSES AND IF IT IS EXPECTED TO REMAIN EXPOSED FOR PERIODS LESS THAN THIRTY (30) DAYS) SHALL HAVE STRAW BALE BERMS OR SILT FENCES CONSTRUCTED AROUND ALL STOCKPILES OF FILL, TOPSOIL AND EXCAVATED OVERBURDEN. STRAW BALE BERMS AND SILT FENCES SHALL BE ANCHORED AND MAINTAINED IN GOOD CONDITION UNTIL SUCH TIME AS SAID STOCKPILES ARE REMOVED AND STOCKPILING AREAS ARE BROUGHT TO FINAL GRADE AND PERMANENTLY STABILIZED.
- 3. IN NO CASE SHALL ERODIBLE MATERIALS BE STOCKPILED WITHIN 25'-0" OF ANY DITCH, STREAM OR OTHER SURFACE WATER BODY.

LITTER AND CONSTRUCTION DEBRIS CONTROL MEASURES:

THE CONTRACTOR SHALL BE RESPONSIBLE FOR COMPLYING WITH THE FOLLOWING LITTER AND CONSTRUCTION DEBRIS CONTROL MEASURES:

- 1. THE CONTRACTOR SHALL DISPOSE OF ALL CONSTRUCTION DEBRIS AT AN OFF-SITE FACILITY APPROVED FOR THE TYPE OF MATERIAL GENERATED AT THE SITE.
- 2. NO BURNING OR BURY PITS WILL BE PERMITTED ON SITE.
- 3. TEMPORARY STORAGE CONTAINERS SHALL BE PROVIDED, AS NECESSARY, TO CONTROL LITTER AND CONSTRUCTION DEBRIS FROM ENTERING ON—SITE STORMWATER DISCHARGES.
- 4. PRIOR TO LEAVING THE SITE EACH DAY, THE CONTRACTOR SHALL INSPECT THE PROJECT SITE AND PLACE ALL LITTER AND CONSTRUCTION DEBRIS IN APPROPRIATE STORAGE CONTAINERS.

MAINTENANCE OF EROSION AND SEDIMENT CONTROL MEASURES:

- INSPECT ALL AREAS THAT HAVE RECEIVED VEGETATION EVERY SEVEN DAYS & AFTER EVERY RAIN EVENT. ALL AREAS DAMAGED BY EROSION OR WHERE SEED HAS NOT ESTABLISHED SHALL BE REPAIRED AND RE—STABILIZED IMMEDIATELY.
- 2. INSPECT SILT FENCE FOR DAMAGE EVERY SEVEN DAYS & AFTER EVERY RAIN EVENT.
 MAKE ALL REPAIRS IMMEDIATELY. REMOVE SEDIMENT FROM THE UP—SLOPE FACE OF THE
 FENCE BEFORE IT ACCUMULATES TO A HEIGHT EQUAL TO 1/3 THE HEIGHT OF THE
 FENCE. IF FENCE FABRIC TEARS, BEGINS TO DECOMPOSE, OR IN ANY WAY BECOMES
 INEFFECTIVE, REPLACE THE AFFECTED SECTION OF FENCE IMMEDIATELY.
- 3. INSPECT SEDIMENT CONTROL BARRIERS (SILT FENCE OR HAY BALE) AND VEGETATION AROUND SOIL STOCKPILES FOR DAMAGE EVERY SEVEN DAYS & AFTER EVERY RAIN EVENT. MAKE ALL REPAIRS IMMEDIATELY. REMOVE SEDIMENT FROM THE UP-SLOPE FACE OF THE SEDIMENT CONTROL BARRIER BEFORE IT ACCUMULATES TO A HEIGHT EQUAL TO 1/3 THE HEIGHT OF THE SEDIMENT CONTROL BARRIER. IF SEDIMENT CONTROL BARRIER TEARS, BEGINS TO DECOMPOSE, OR IN ANYWAY BECOMES INEFFECTIVE, REPLACE THE AFFECTED SECTION OF SEDIMENT CONTROL BARRIER IMMEDIATELY. REVEGETATE DISTURBED AREA TO STABILIZE SOIL STOCK PILE. REMOVE THE SEDIMENT CONTROL BARRIER WHEN THE SOIL STOCKPILE HAS BEEN REMOVED.
- 4. IN ORDER TO MAXIMIZE DUST CONTROL, SCHEDULE CONSTRUCTION OPERATIONS TO MINIMIZE THE AMOUNT OF DISTURBED AREAS AT ANY ONE TIME DURING THE COURSE OF WORK. APPLY TEMPORARY SOIL STABILIZATION PRACTICES SUCH AS MULCHING, SEEDING, AND SPRAYING (WATER). STRUCTURAL MEASURES (MULCH, SEEDING) SHALL BE INSTALLED IN DISTURBED AREAS BEFORE SIGNIFICANT BLOWING PROBLEMS DEVELOP. WATER SHALL BE SPRAYED AS NEEDED. REPEAT AS NEEDED, BUT AVOID EXCESSIVE SPRAYING, WHICH COULD CREATE RUNOFF AND EROSION PROBLEMS.
- INSPECT ALL STORM DRAIN INLET PROTECTION DEVICES WITHIN PROJECT AREA EVERY SEVEN DAYS & AFTER EVERY RAIN EVENT. MAKE REPAIRS AS NEEDED, REMOVE SEDIMENT FROM THE POOL AREA AS NECESSARY.

BYPASS PUMPING NOTES:

- 1. CONTRACTOR SHALL PROVIDE BYPASS PUMPING TO MAINTAIN SANITARY SEWER FLOWS THROUGHOUT THE DURATION OF THE CONTRACT.
- 2. PERFORM BYPASS PUMPING IN ACCORDANCE WITH SPECIFICATION 015720.

WORK ZONE TRAFFIC CONTROL NOTES:

- CONTRACTOR SHALL PROVIDE TEMPORARY WORK ZONE TRAFFIC CONTROL FOR ALL IMPACTS TO ROADWAY TRAVEL WIDTH. REFER TO SPECIFICATION SECTION 015526 AND THE CONTRACT DRAWINGS FOR TRAFFIC MAINTENANCE AND PROTECTION SPECIFICATIONS AND NYSDOT WORK ZONE TRAFFIC CONTROL DETAILS.
- 2. CONTRACTOR SHALL RESTORE ROADWAY TRAVEL WIDTHS AT THE END OF EACH WORK

TREE PROTECTION NOTES:

AND COMB SOIL TO EXPOSE ROOTS.

- PROVIDE TEMPORARY FENCING, BARRICADES OR OTHER SUITABLE REMAINING GUARDS LOCATED OUTSIDE THE TREE DRIP LINE (OUTER PERIMETER OF BRANCHES) TO PROTECT TREES AND OTHER PLANTS FROM DAMAGE.
- 2. DO NOT STORE CONSTRUCTION MATERIALS, DEBRIS OR EXCAVATED MATERIAL WITHIN THE TREE DRIP LINE OF REMAINING TREES. DO NOT PERMIT VEHICLES OR FOOT TRAFFIC WITHIN THE DRIP LINE, AND PREVENT SOIL COMPACTION OVER ROOT SYSTEMS.
- 3. WHERE EXCAVATION FOR NEW CONSTRUCTION IS REQUIRED WITHIN TREE DRIP LINES, HAND

EXCAVATE TO MINIMIZE DAMAGE TO ROOT SYSTEMS. USE NARROW TINE SPADING FORKS


- 4. DO NOT ALLOW EXPOSED ROOTS TO DRY OUT BEFORE PLACING PERMANENT BACKFILL. PROVIDE TEMPORARY EARTH COVER OR PACK WITH PEAT MOSS AND WRAP WITH BURLAP. WATER AND MAINTAIN ROOTS IN A MOIST CONDITION, AND TEMPORARILY SUPPORT AND PROTECT ROOTS FROM DAMAGE UNTIL THEY ARE PERMANENTLY RELOCATED AND COVERED WITH EARTH.
- WHERE UTILITY TRENCHES ARE REQUIRED WITHIN TREE DRIP LINES, TUNNEL UNDER OR AROUND THE ROOTS BY DRILLING, AUGER, BORING PIPE, JACKING OR DIGGING BY HAND AS REQUIRED.
- 6. ROOT PRUNING: DO NOT CUT MAIN LATERAL ROOTS OR TAP ROOTS; CUT ONLY SMALLER ROOTS THAT INTERFERE WITH INSTALLATION OF NEW WORK. CUT ROOTS WITH A SHARP PRUNING INSTRUMENT; DO NOT BREAK OR CHOP.
- 7. DO NOT REGRADE MORE THAN 6" ABOVE EXISTING GRADE AROUND TREES. PROVIDE TREE
- 8. PRUNE REMAINING TREES AFFECTED BY TEMPORARY AND NEW CONSTRUCTION. CUT BRANCHES WITH SHARP PRUNING INSTRUMENTS; DO NOT BREAK OR CHOP.
- 9. PRUNE REMAINING TREES TO COMPENSATE FOR ROOT LOSS CAUSED BY DAMAGING OR CUTTING ROOT SYSTEM. PROVIDE SUBSEQUENT MAINTENANCE DURING THE ENTIRE CONTRACT/WARRANTY PERIOD.
- 10. PRUNE TREES ACCORDING TO THE NATIONAL ARBORIST ASSOCIATION'S "PRUNING STANDARDS FOR SHADE TREES."
- 11. CHIP BRANCHES REMOVED FROM TREES. SPREAD MATERIALS WHERE INDICATED, OR AS DIRECTED BY THE OWNER'S REPRESENTATIVE.

ALL UNNECESSARY REMOVAL OF HEALTHY TREES SHALL BE AVOIDED, UNLESS OTHERWISE

NOTED ON THE CONTRACT PLANS. REMOVAL OF ANY TREES SHALL BE COORDINATED WITH THE TOWN. MATERIALS SHALL NOT BE STORED, AND MACHINERY SHALL NOT BE OPERATED, WITHIN THE DRIP LINE OF TREES TO REMAIN.

GROVE STREET

SANITARY SEWER LINING, REFER TO SHEET C-120

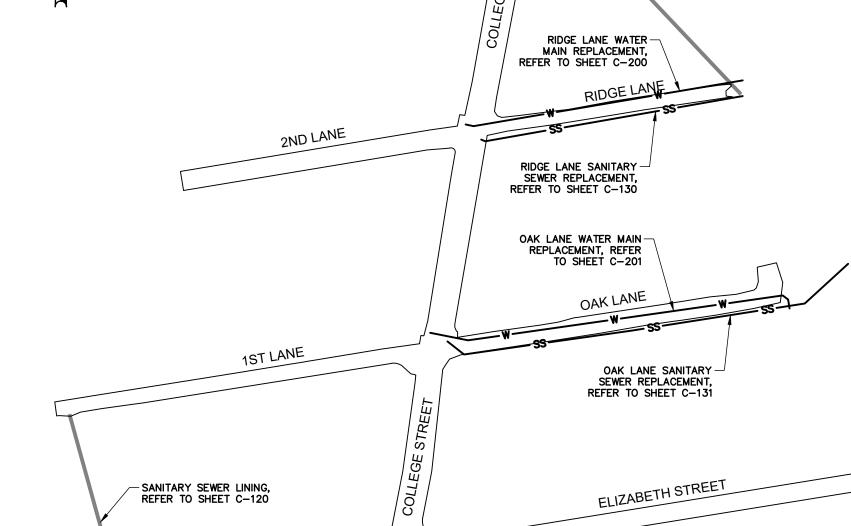

KEY PLAN

ELIZABETH STREE'I

SCALE: N.T.S.

THE ALTERATION OF THIS MATERIAL IN ANY WAY, UNLESS DONE UNDER THE DIRECTION OF A COMPARABLE PROFESSIONAL, (I.E.) ARCHITECT FOR AN ARCHITECT, ENGINEER FOR AN ENGINEER OR LAND SURVEYOR FOR A LAND SURVEYOR, IS A VIOLATION OF THE NEW YORK STATE EDUCATION LAW AND/OR REGULATIONS AND IS

A CLASS "A" MISDEMEANOR.



TOWN OF MORIAH

GENERAL NOTES, LEGEND, AND KEY PLAN

WATER AND SEWER UPGRADES
ESSEX COUNTY NEW YO

G-002

SCALE: N.T.S

CONTRACT No.: MJ PROJ. No.: 1075.03

DATE: 12/18/19

CONCRETE SIDEWALK

ASPHALT WING GUTTER


12/18/19 | BID DOCUMENTS

SUBMITTAL / REVISIONS

DESCRIPTION

RESTORATION

RESTORATION

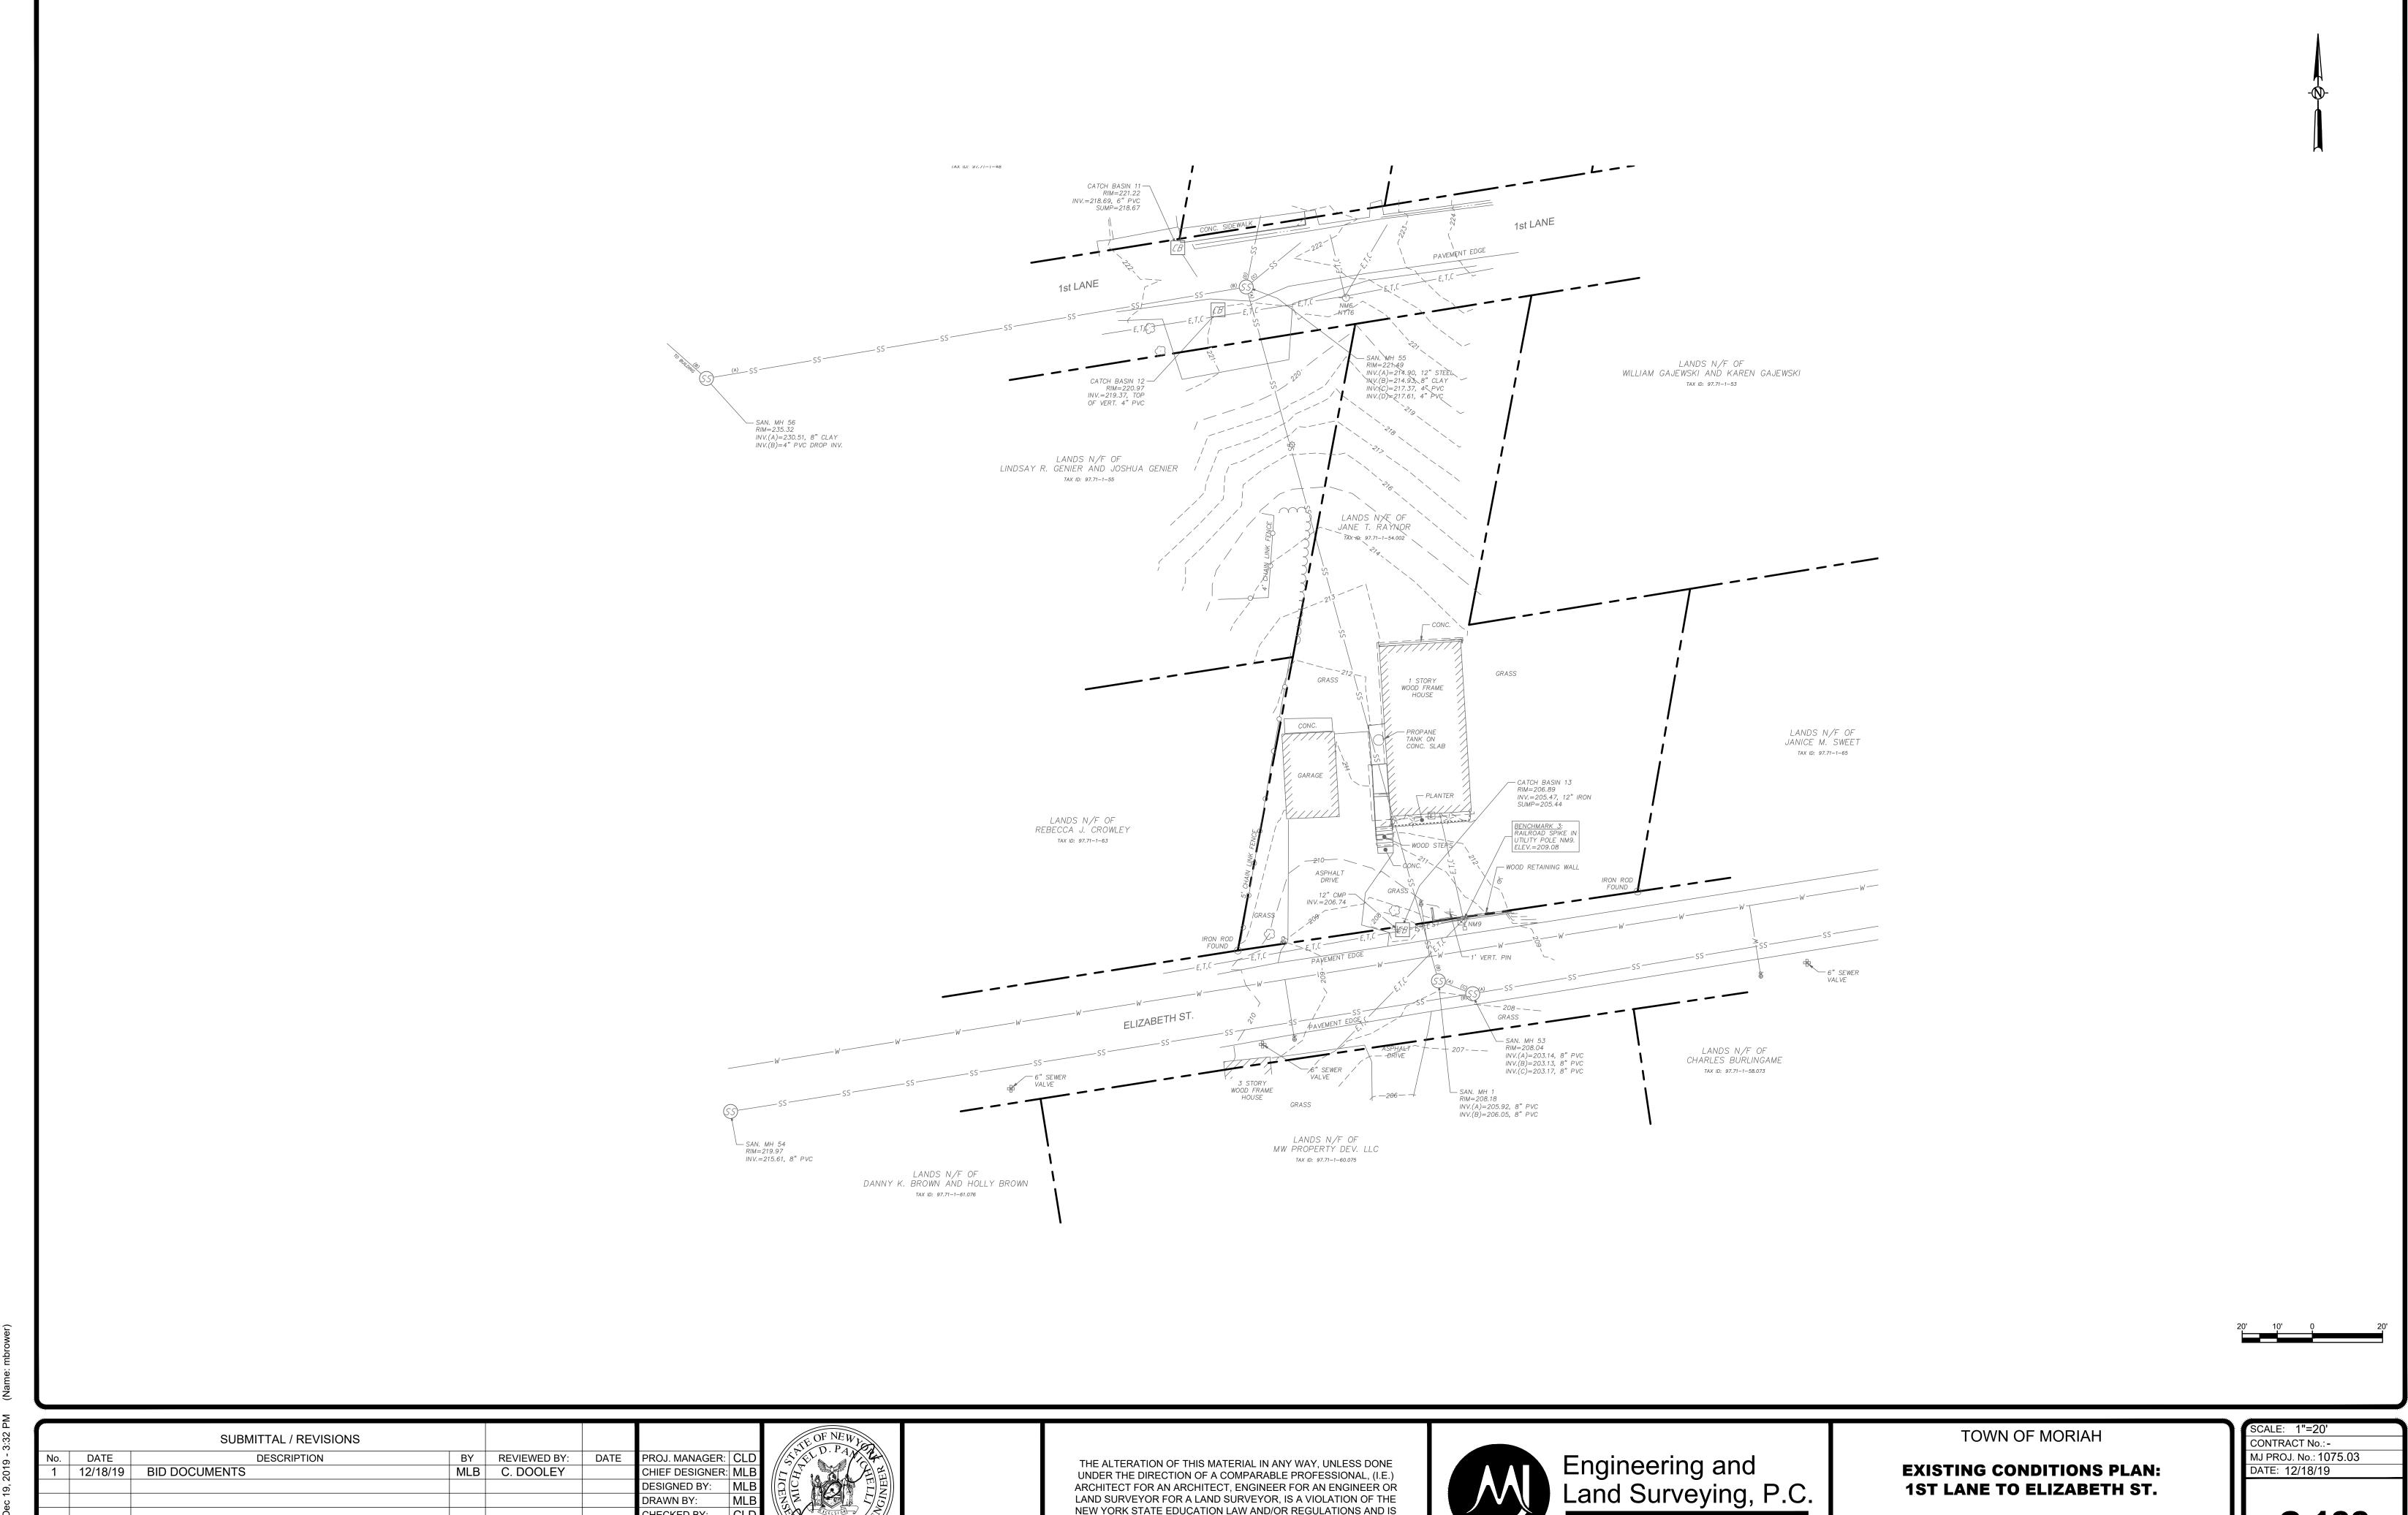

NEW YORK STATE EDUCATION LAW AND/OR REGULATIONS AND IS A CLASS "A" MISDEMEANOR.

1ST LANE TO ELIZABETH ST.

WATER AND SEWER UPGRADES

ESSEX COUNTY

NEW YORK

1533 Crescent Road - Clifton Park, NY 12065

C-100


DESIGNED BY:

CHECKED BY:

POFESSION

DATE

DRAWN BY:

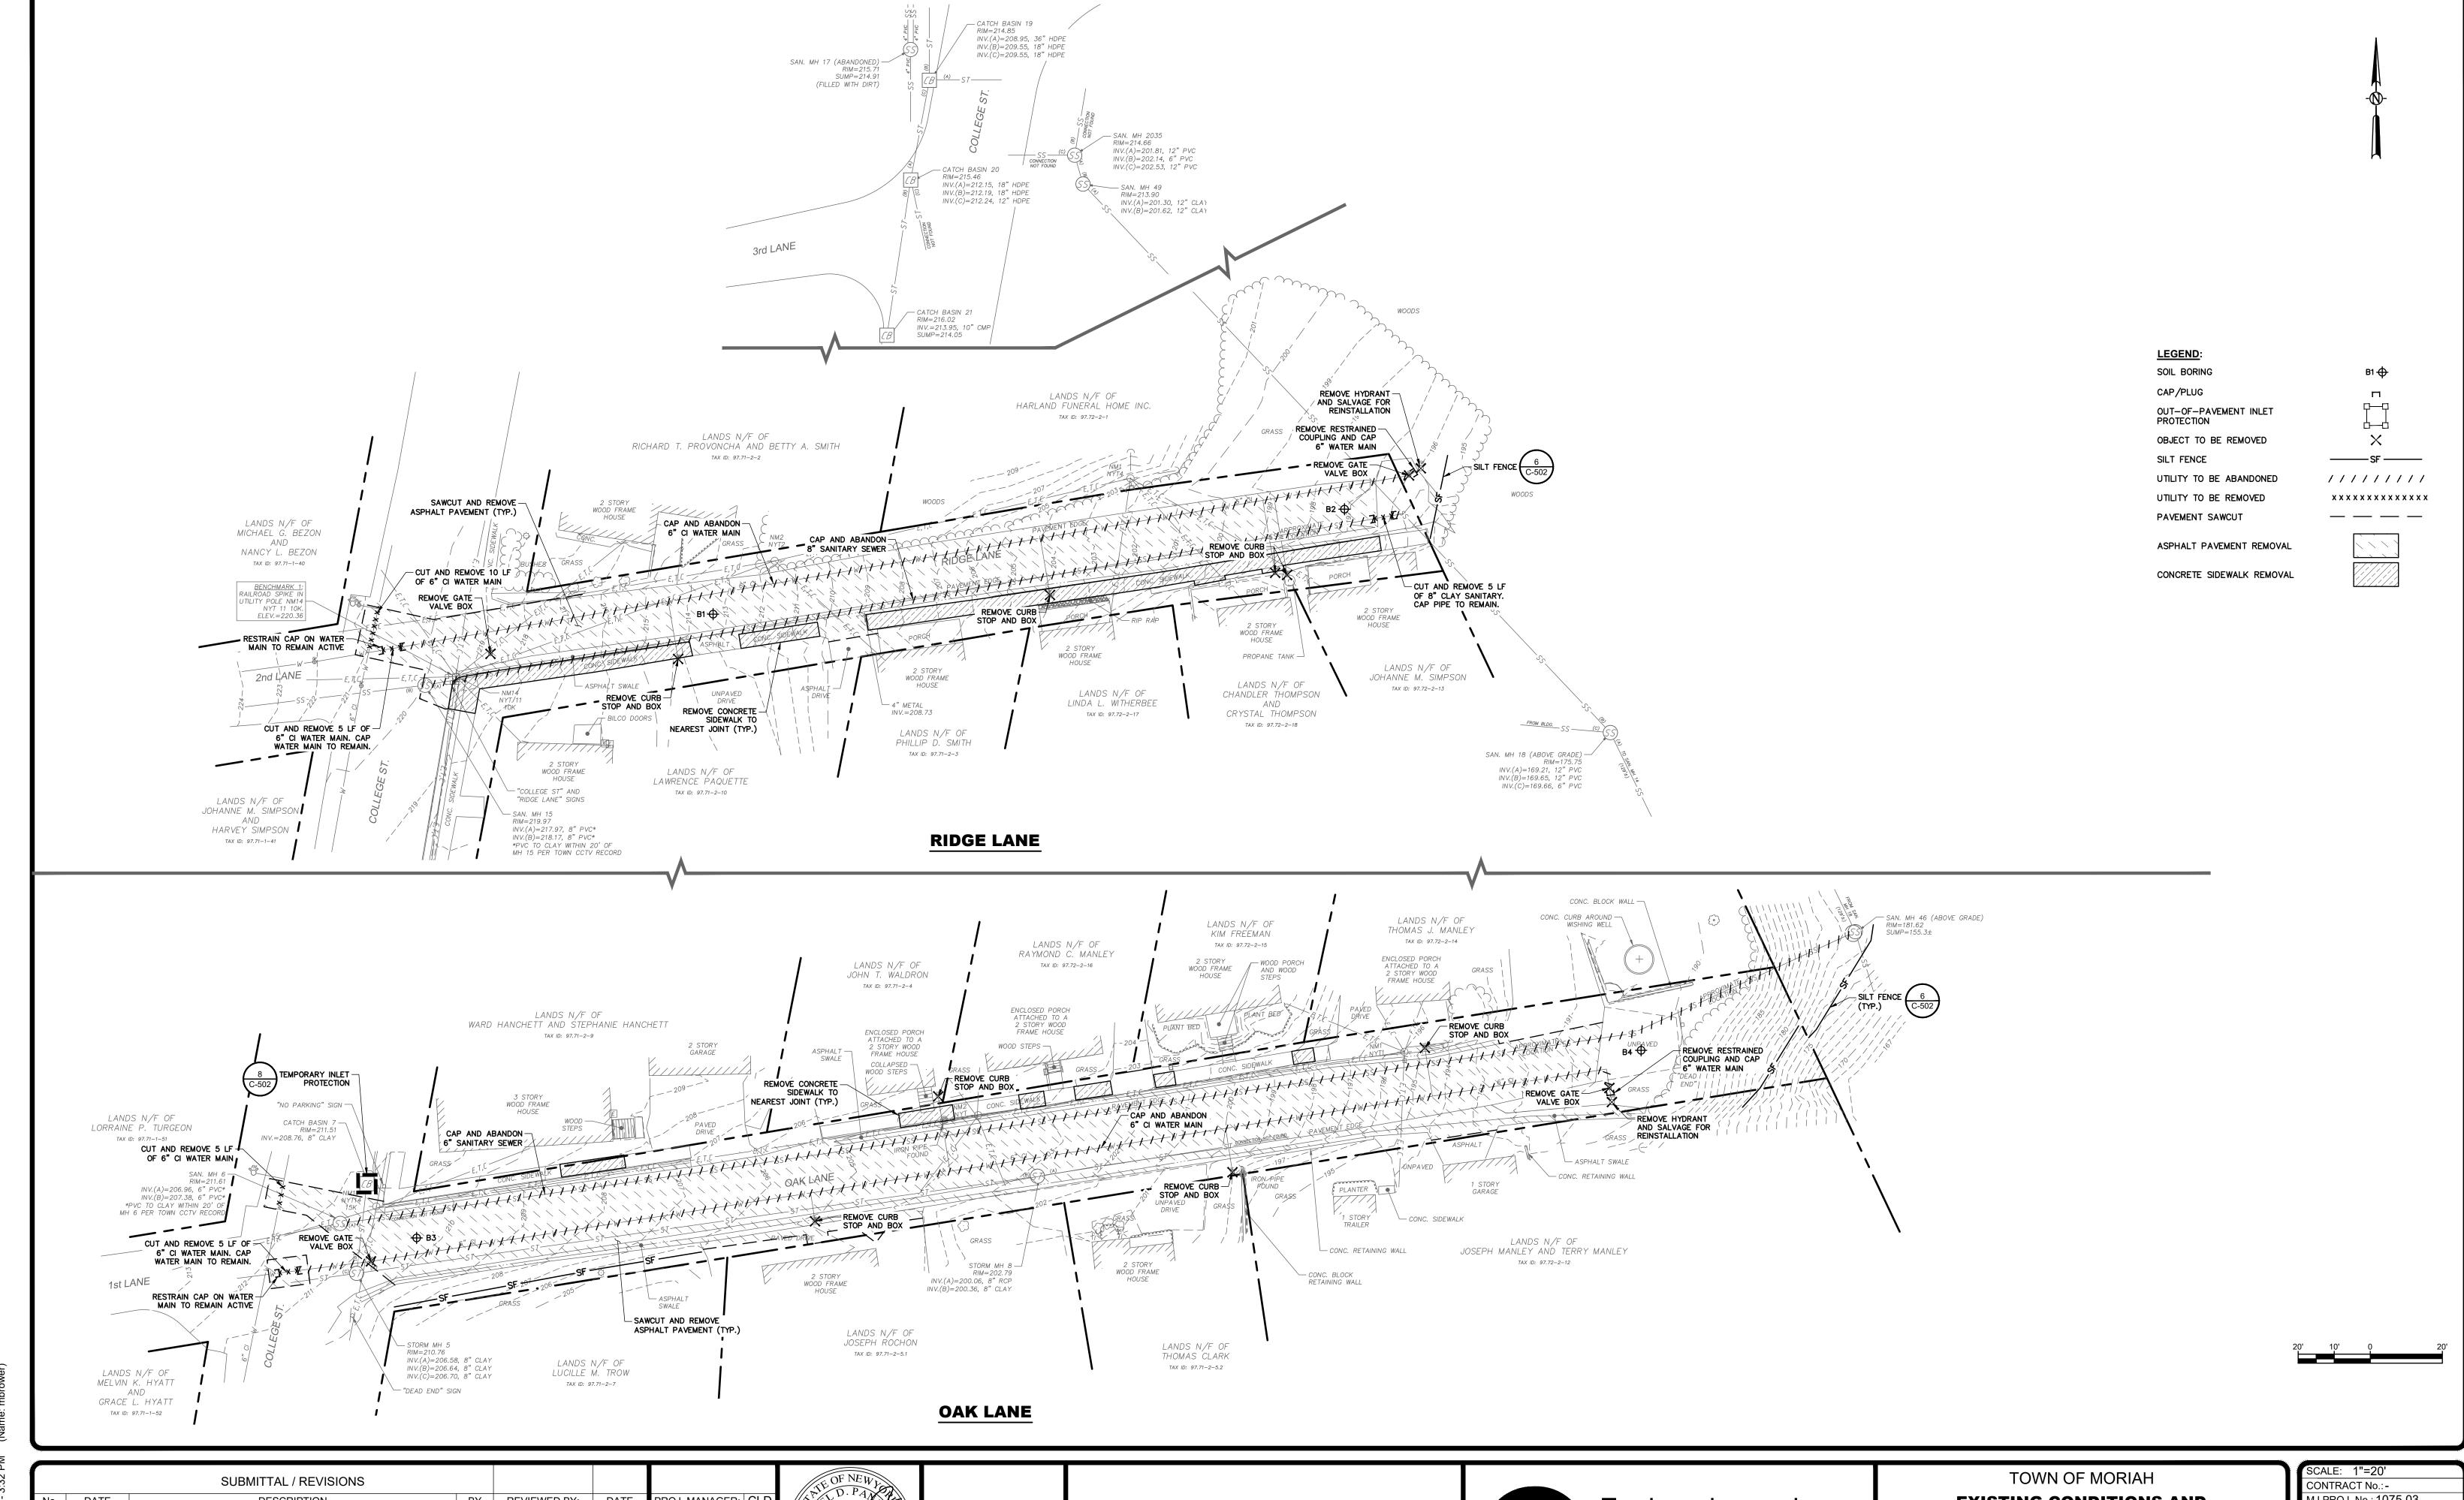

File Name: F:\MJ1075\1075.03 Town of Moriah Water and Sewer\MJ1075.03 C-100 EXIST COND.

THE ALTERATION OF THIS MATERIAL IN ANY WAY, UNLESS DONE UNDER THE DIRECTION OF A COMPARABLE PROFESSIONAL, (I.E.) ARCHITECT FOR AN ARCHITECT, ENGINEER FOR AN ENGINEER OR LAND SURVEYOR FOR A LAND SURVEYOR, IS A VIOLATION OF THE NEW YORK STATE EDUCATION LAW AND/OR REGULATIONS AND IS A CLASS "A" MISDEMEANOR.


Engineering and Land Surveying, P.C.

1533 Crescent Road - Clifton Park, NY 12065

EXISTING CONDITIONS AND REMOVALS PLAN: COLLEGE ST., RIDGE LANE, OAK LANE

WATER AND SEWER UPGRADES
ESSEX COUNTY NEW YORK

SCALE: 1"=20'
CONTRACT No.:MJ PROJ. No.: 1075.03
DATE: 12/18/19

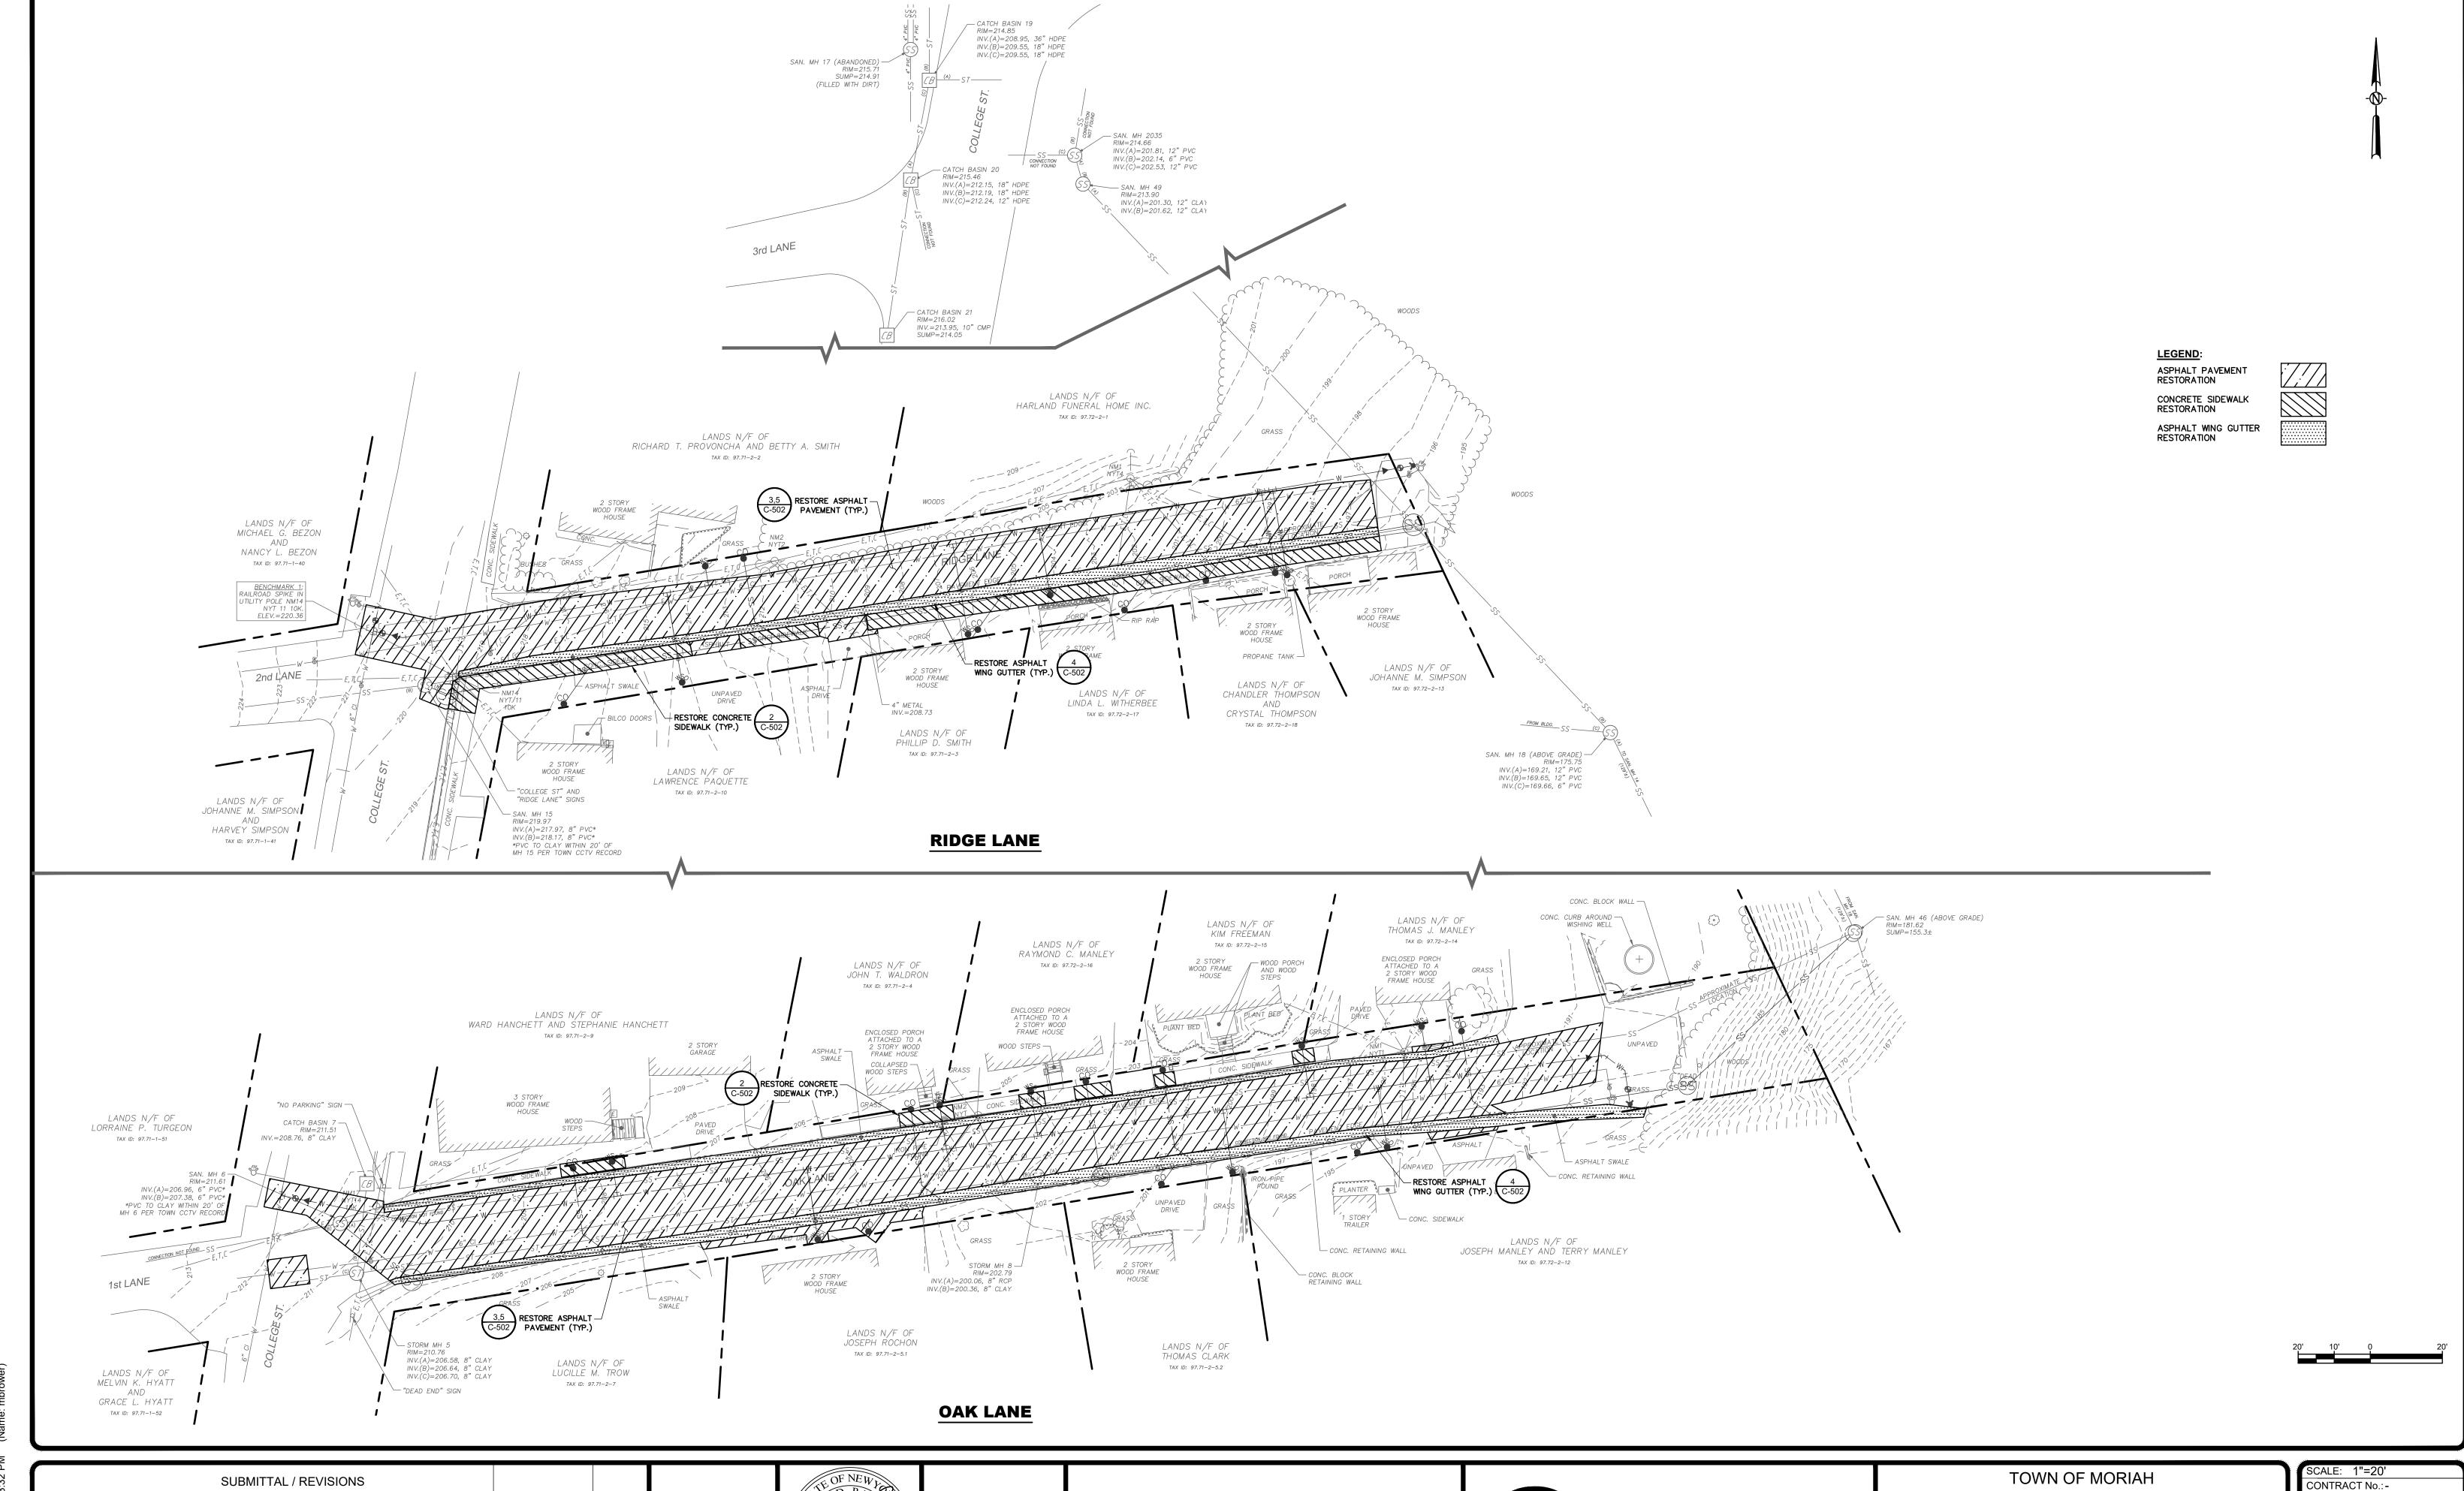

THE ALTERATION OF THIS MATERIAL IN ANY WAY, UNLESS DONE

UNDER THE DIRECTION OF A COMPARABLE PROFESSIONAL, (I.E.)

ARCHITECT FOR AN ARCHITECT, ENGINEER FOR AN ENGINEER OR

LAND SURVEYOR FOR A LAND SURVEYOR, IS A VIOLATION OF THE NEW YORK STATE EDUCATION LAW AND/OR REGULATIONS AND IS

A CLASS "A" MISDEMEANOR.

File Name: F:\MJ1075\1075.03 Town of Moriah Water and Sewer\MJ1075.03 C-110 RESTORATION.c

DESCRIPTION

12/18/19 BID DOCUMENTS

BY REVIEWED BY:

MLB C. DOOLEY

PROJ. MANAGER: CLE

DESIGNED BY:

CHECKED BY:

DRAWN BY:

CHIEF DESIGNER: MLB

ROFESSION

DATE

Engineering and Land Surveying, P.C.

1533 Crescent Road - Clifton Park, NY 12065


SITE RESTORATION PLAN: COLLEGE ST., RIDGE LANE, OAK LANE

WATER AND SEWER UPGRADES
ESSEX COUNTY NEW YORK

C-110

MJ PROJ. No.: 1075.03

DATE: 12/18/19

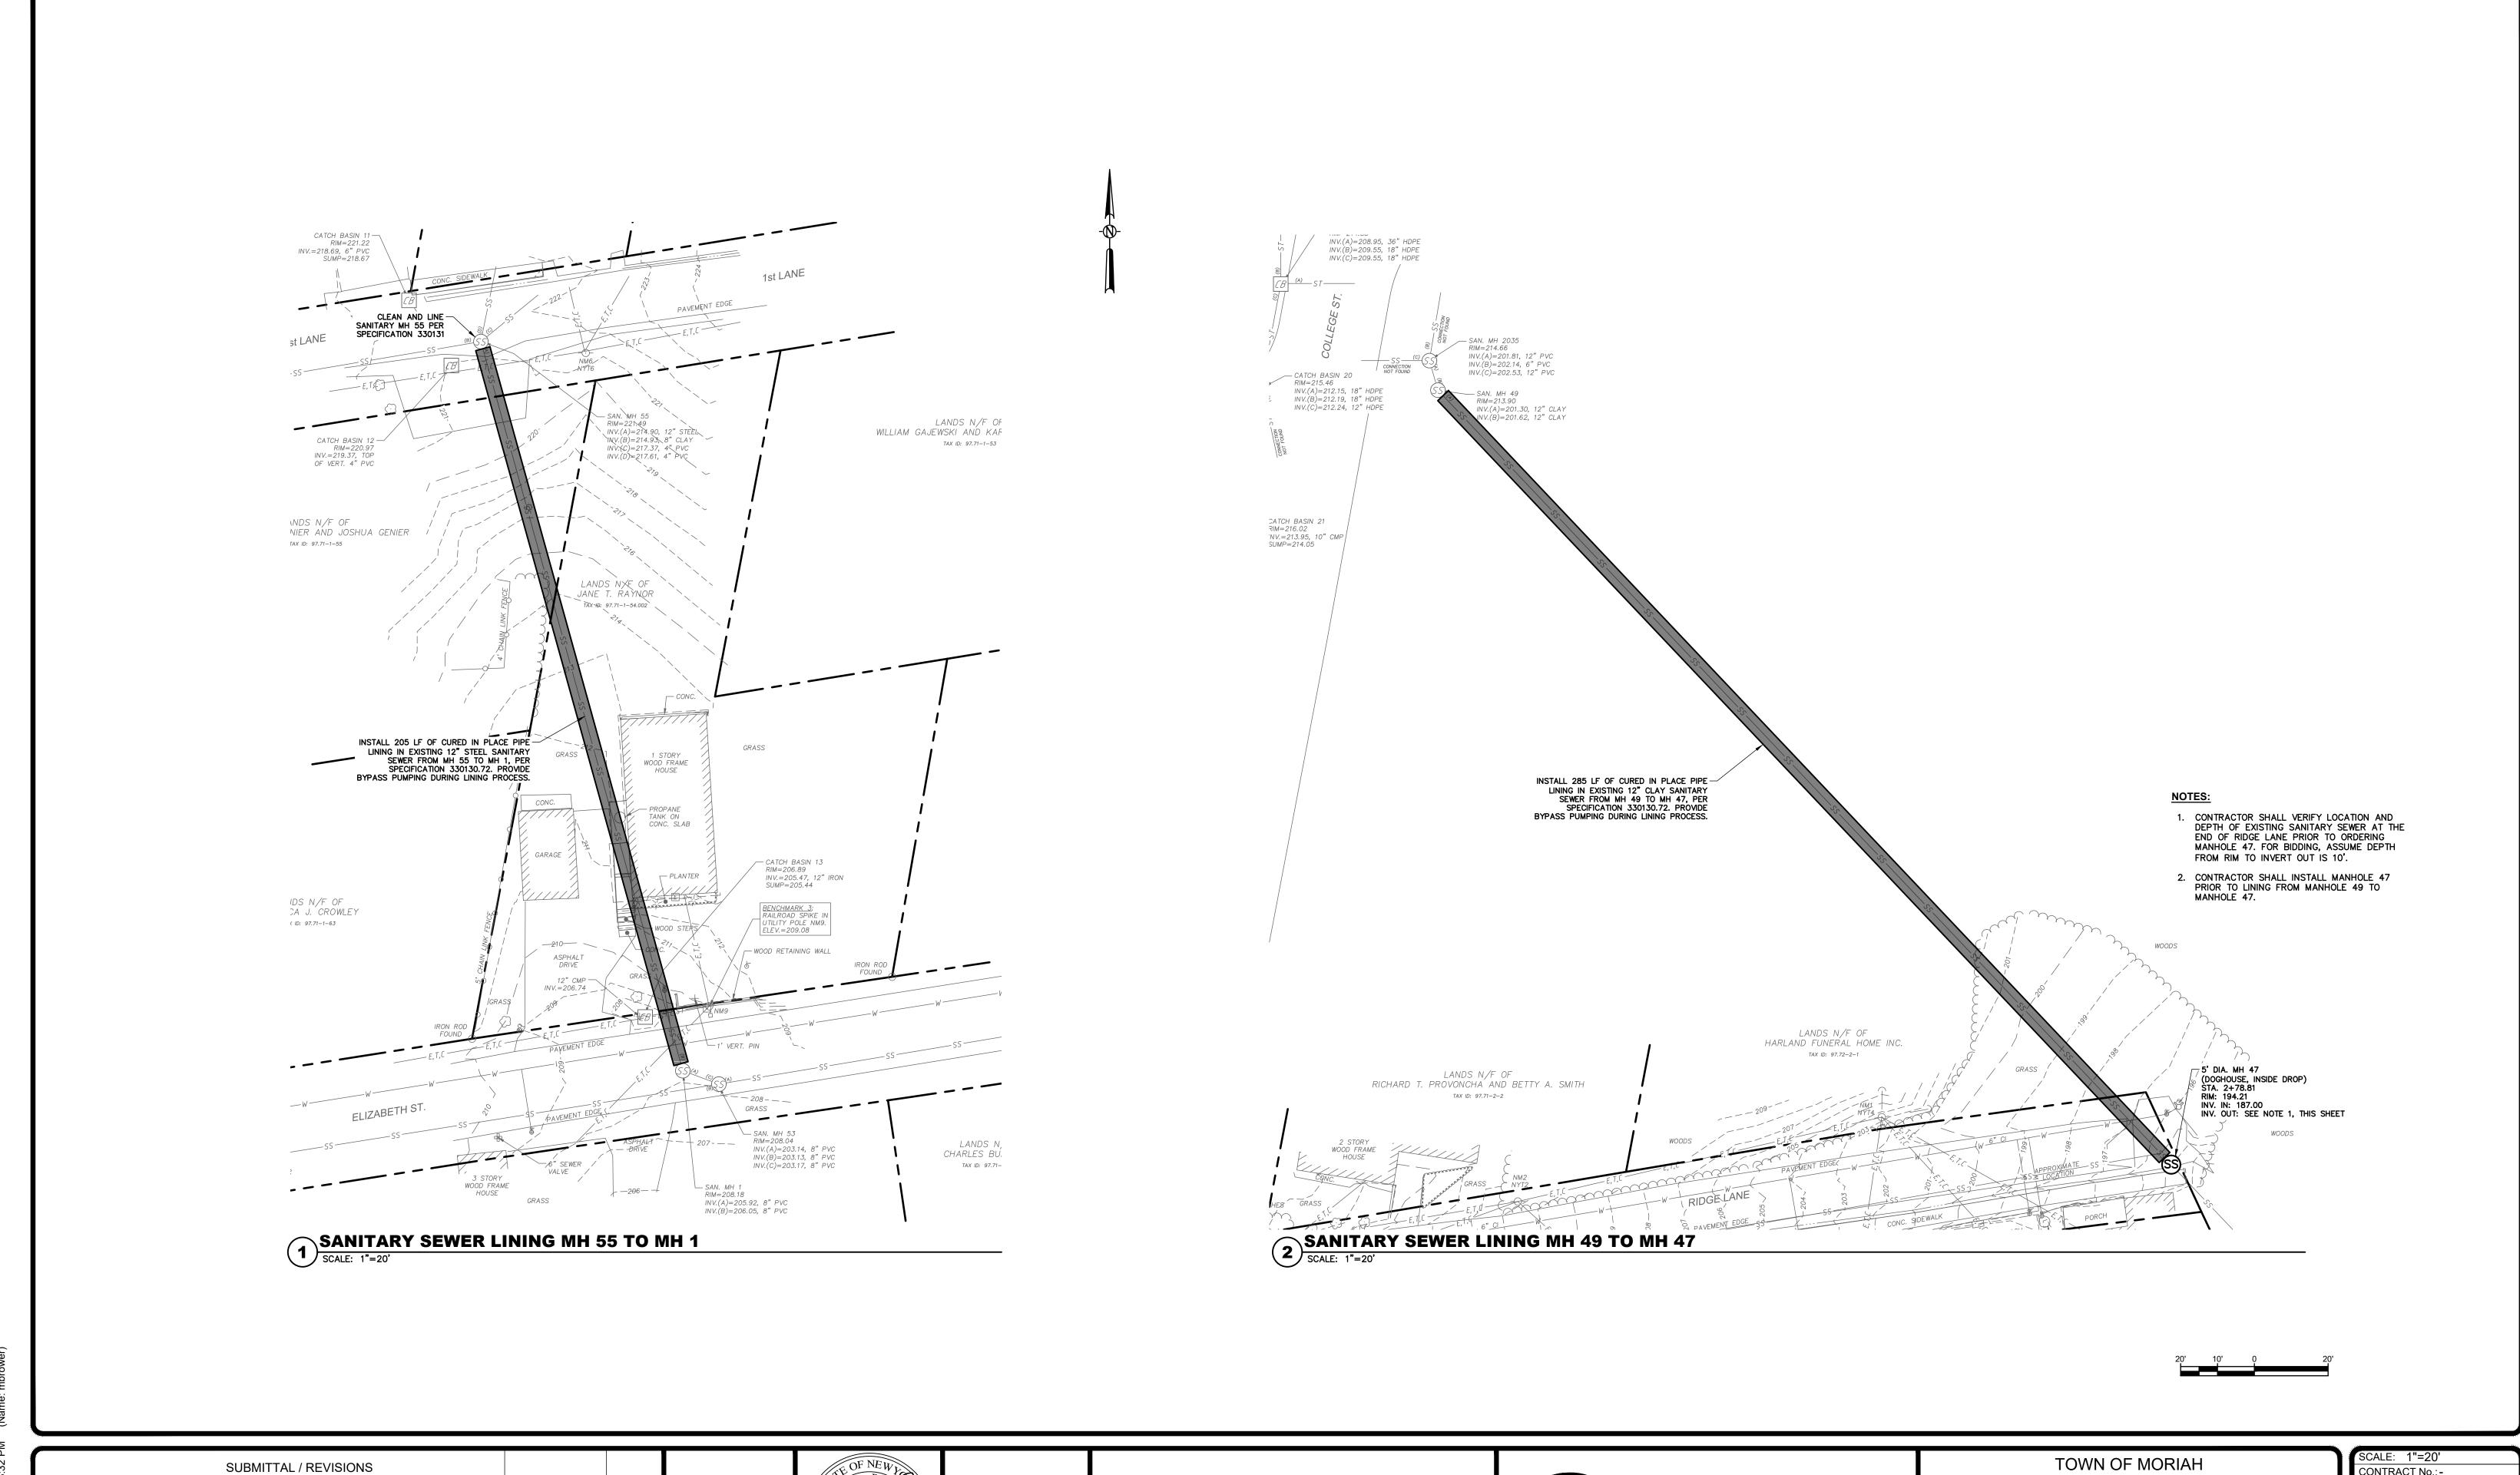

DESCRIPTION

12/18/19 BID DOCUMENTS

BY REVIEWED BY:

MLB C. DOOLEY

DATE

PROJ. MANAGER: CLE

DESIGNED BY:

CHECKED BY:

DRAWN BY:

CHIEF DESIGNER: MLB

ROFESSION

DATE

THE ALTERATION OF THIS MATERIAL IN ANY WAY, UNLESS DONE UNDER THE DIRECTION OF A COMPARABLE PROFESSIONAL, (I.E.) ARCHITECT FOR AN ARCHITECT, ENGINEER FOR AN ENGINEER OR LAND SURVEYOR FOR A LAND SURVEYOR, IS A VIOLATION OF THE NEW YORK STATE EDUCATION LAW AND/OR REGULATIONS AND IS A CLASS "A" MISDEMEANOR.


Engineering and Land Surveying, P.C. 1533 Crescent Road - Clifton Park, NY 12065

TOWN OF MORIAH

SANITARY SEWER LINING PLAN

WATER AND SEWER UPGRADES **NEW YORK ESSEX COUNTY**

		Nr.
7	i	SCALE: 1"=20'
ı		CONTRACT No.:-
ı		MJ PROJ. No.: 1075.03
ı		DATE: 12/18/19
ı		
ı		

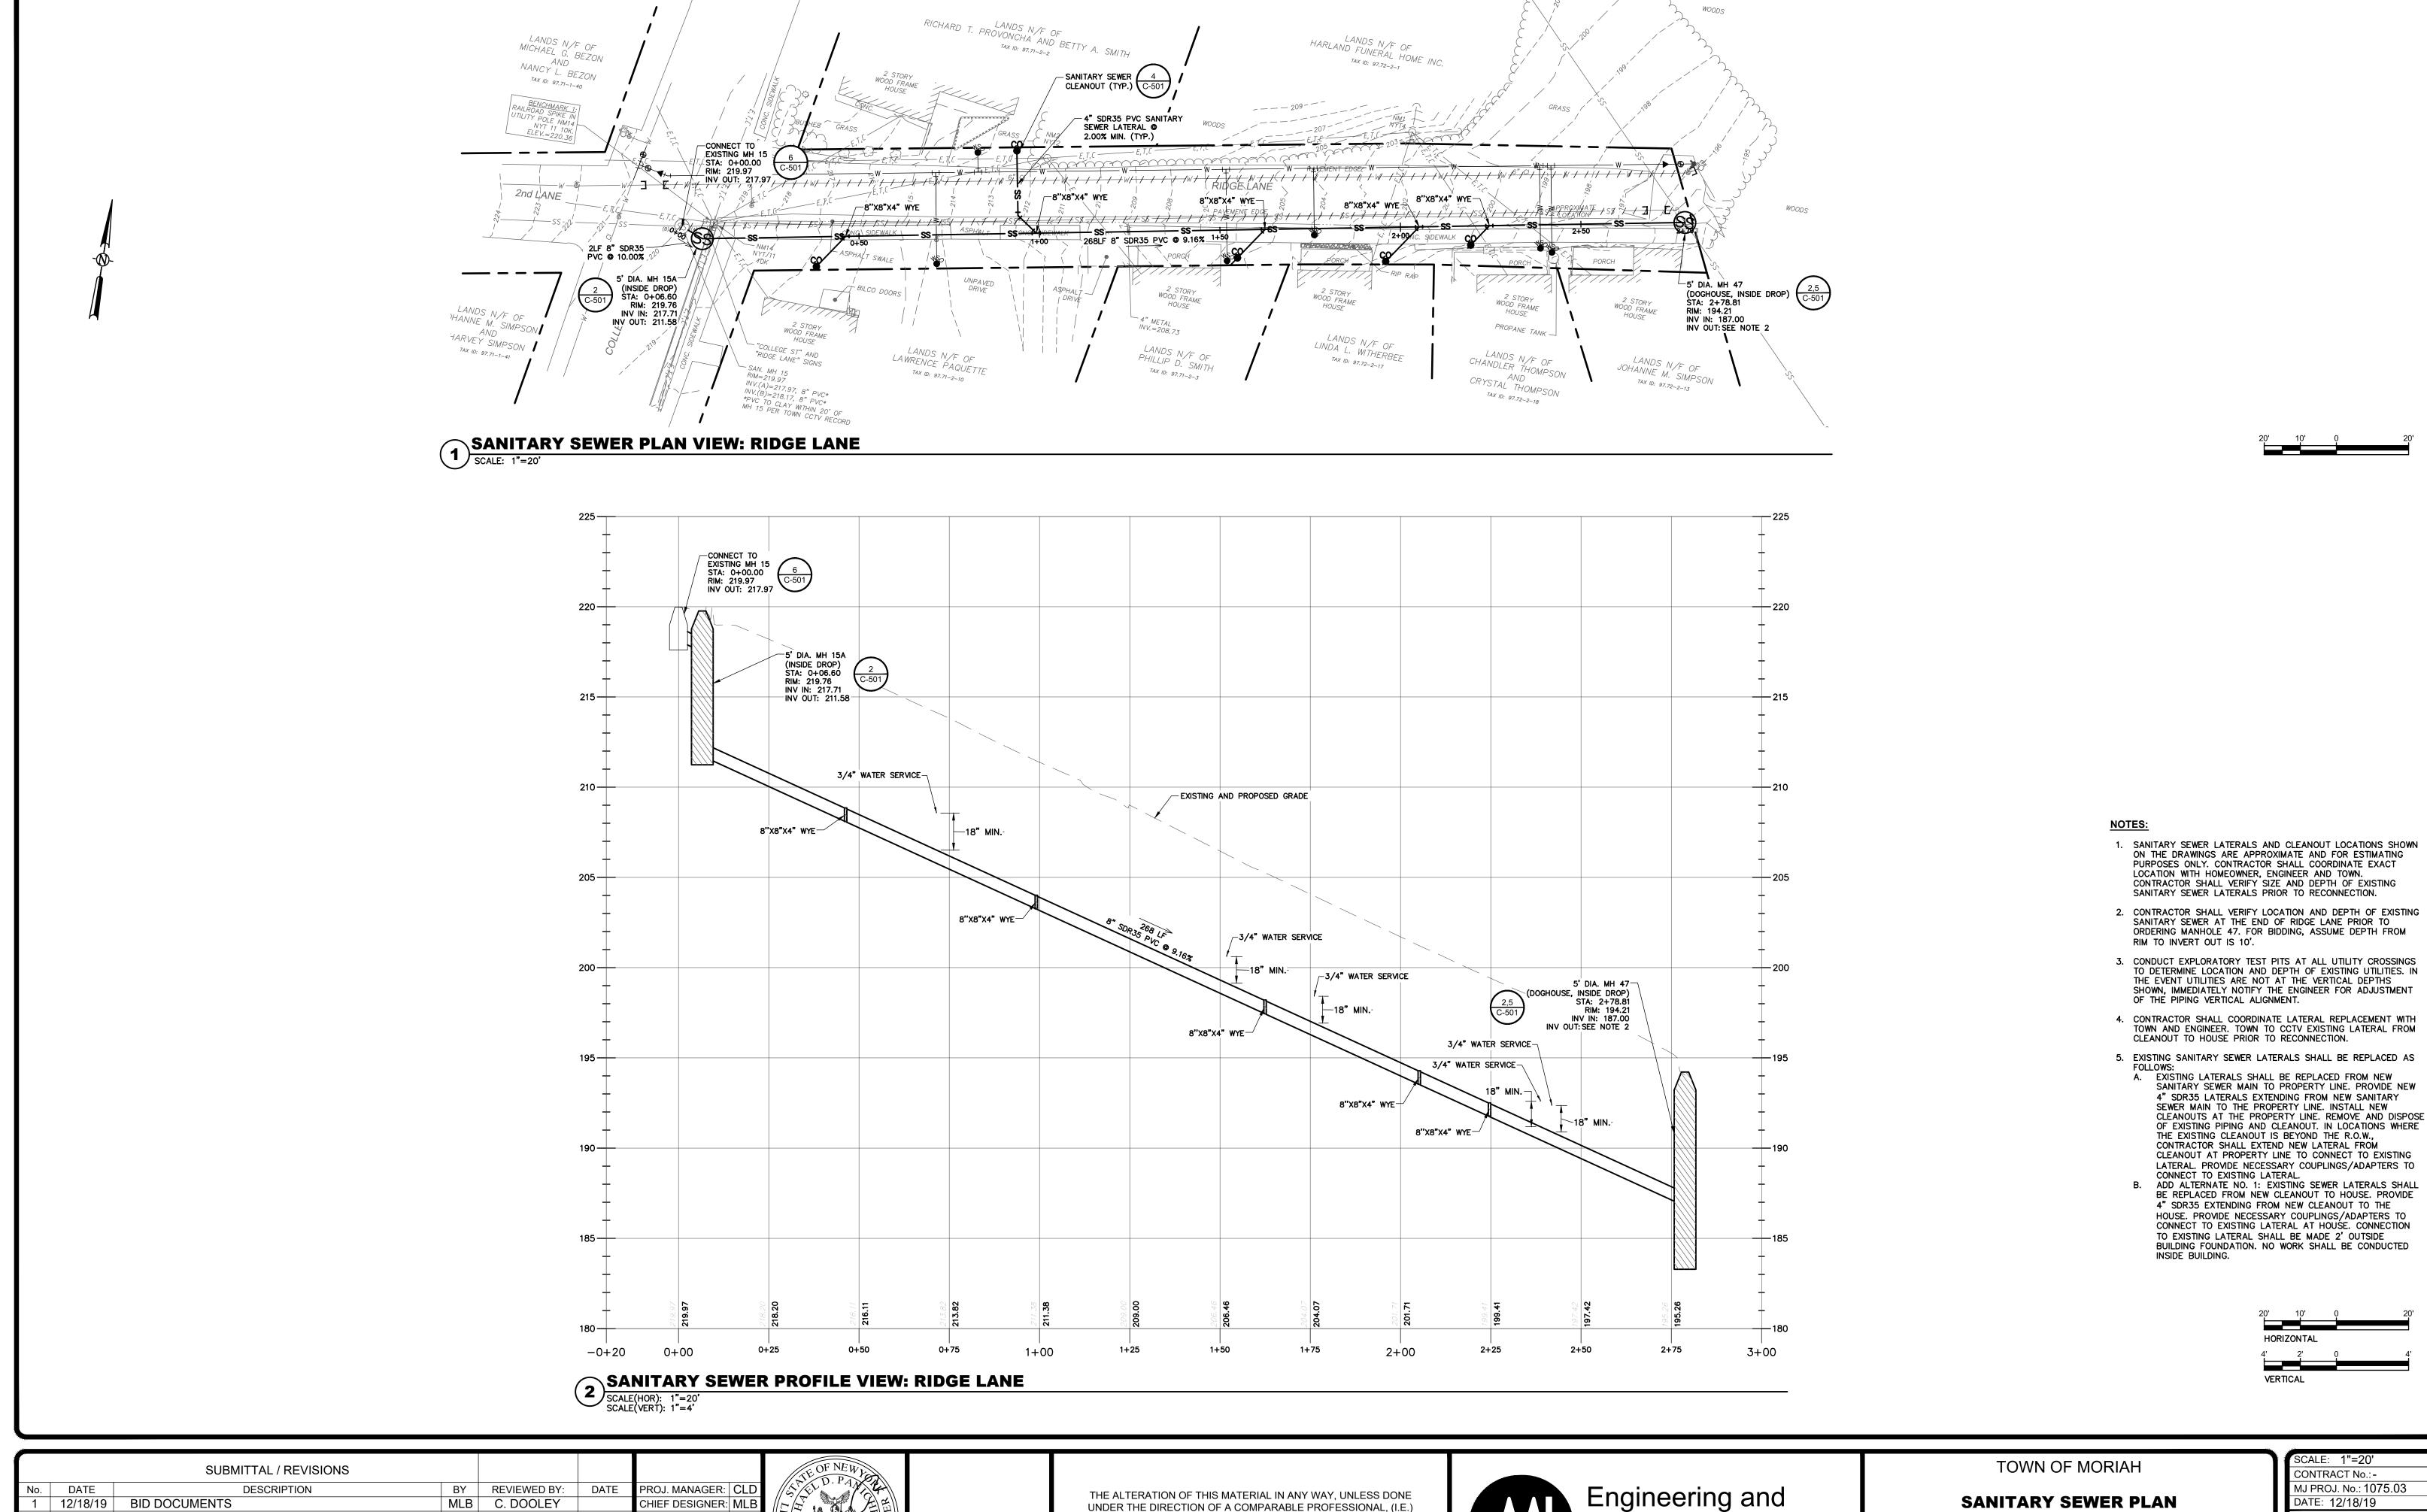

ARCHITECT FOR AN ARCHITECT, ENGINEER FOR AN ENGINEER OR

LAND SURVEYOR FOR A LAND SURVEYOR, IS A VIOLATION OF THE

NEW YORK STATE EDUCATION LAW AND/OR REGULATIONS AND IS

A CLASS "A" MISDEMEANOR.

DESIGNED BY:

CHECKED BY:

ROFESSION


DATE

DRAWN BY:

Engineering and Land Surveying, P.C. 1533 Crescent Road - Clifton Park, NY 12065

SANITARY SEWER PLAN AND PROFILE: RIDGE LANE

WATER AND SEWER UPGRADES **NEW YORK** ESSEX COUNTY

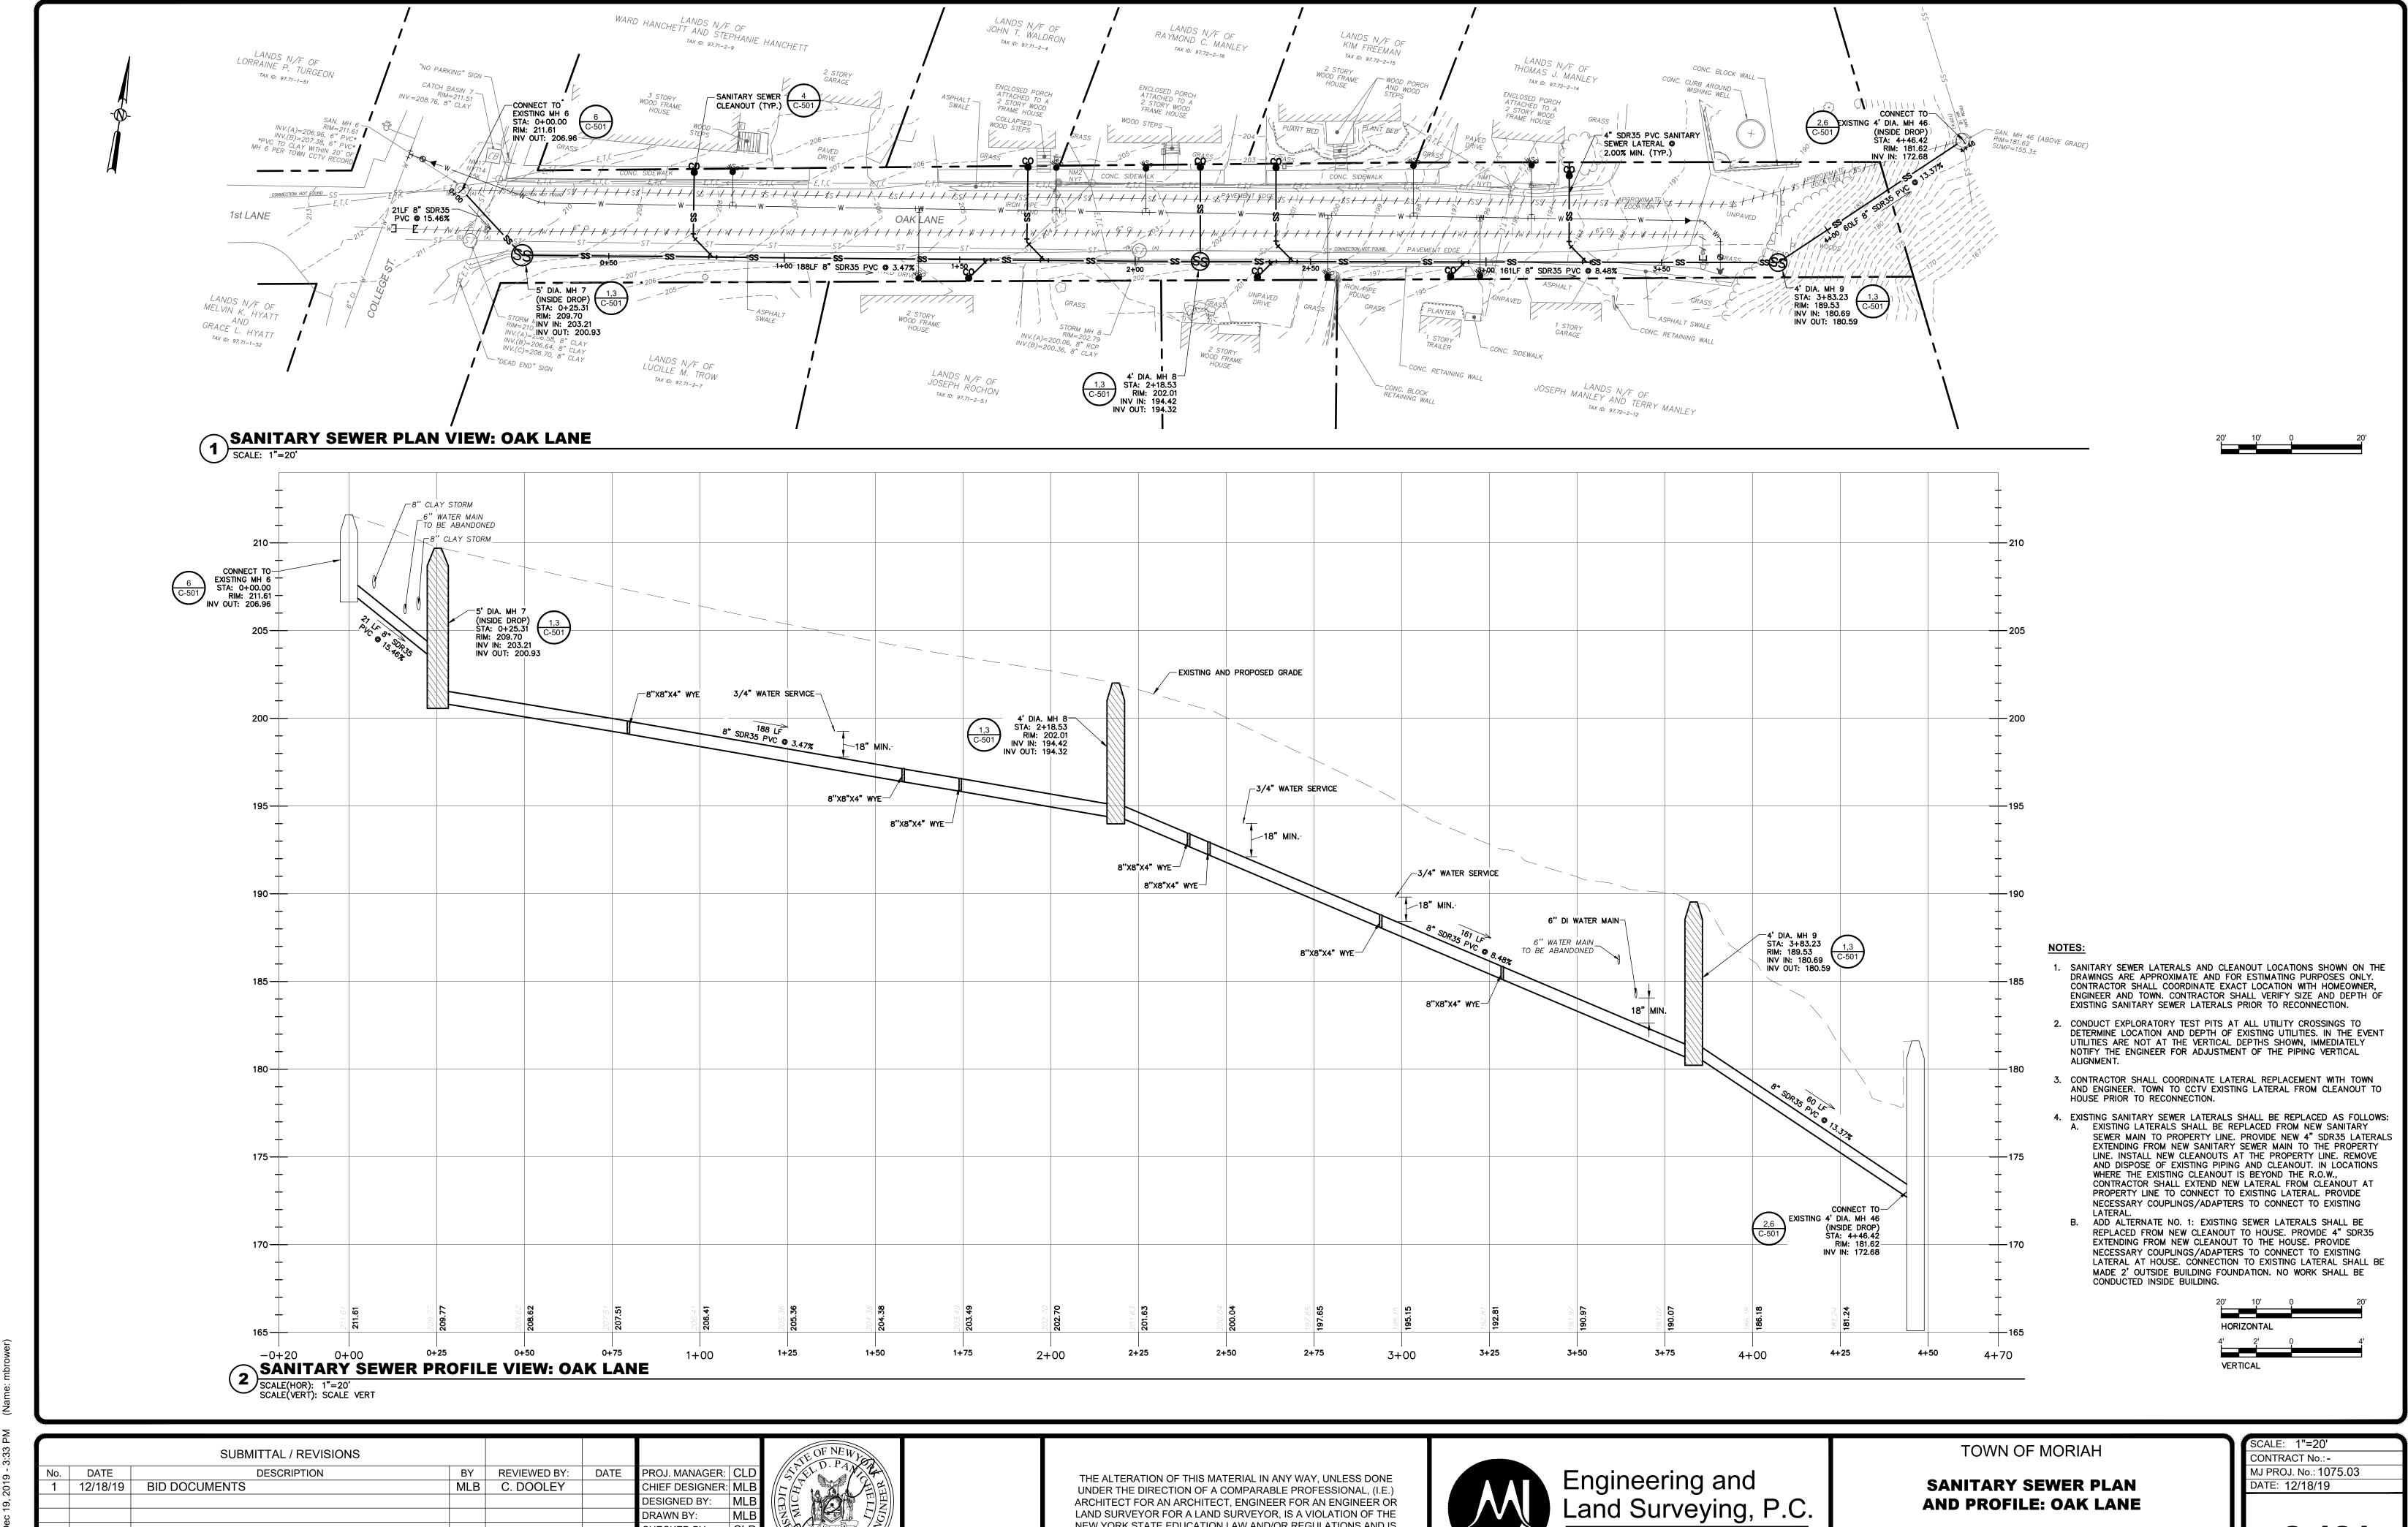

NEW YORK STATE EDUCATION LAW AND/OR REGULATIONS AND IS

A CLASS "A" MISDEMEANOR.

DRAWN BY:

CHECKED BY:


POFESSIO!

DATE

1533 Crescent Road - Clifton Park, NY 12065


AND PROFILE: OAK LANE

WATER AND SEWER UPGRADES **NEW YORK** ESSEX COUNTY

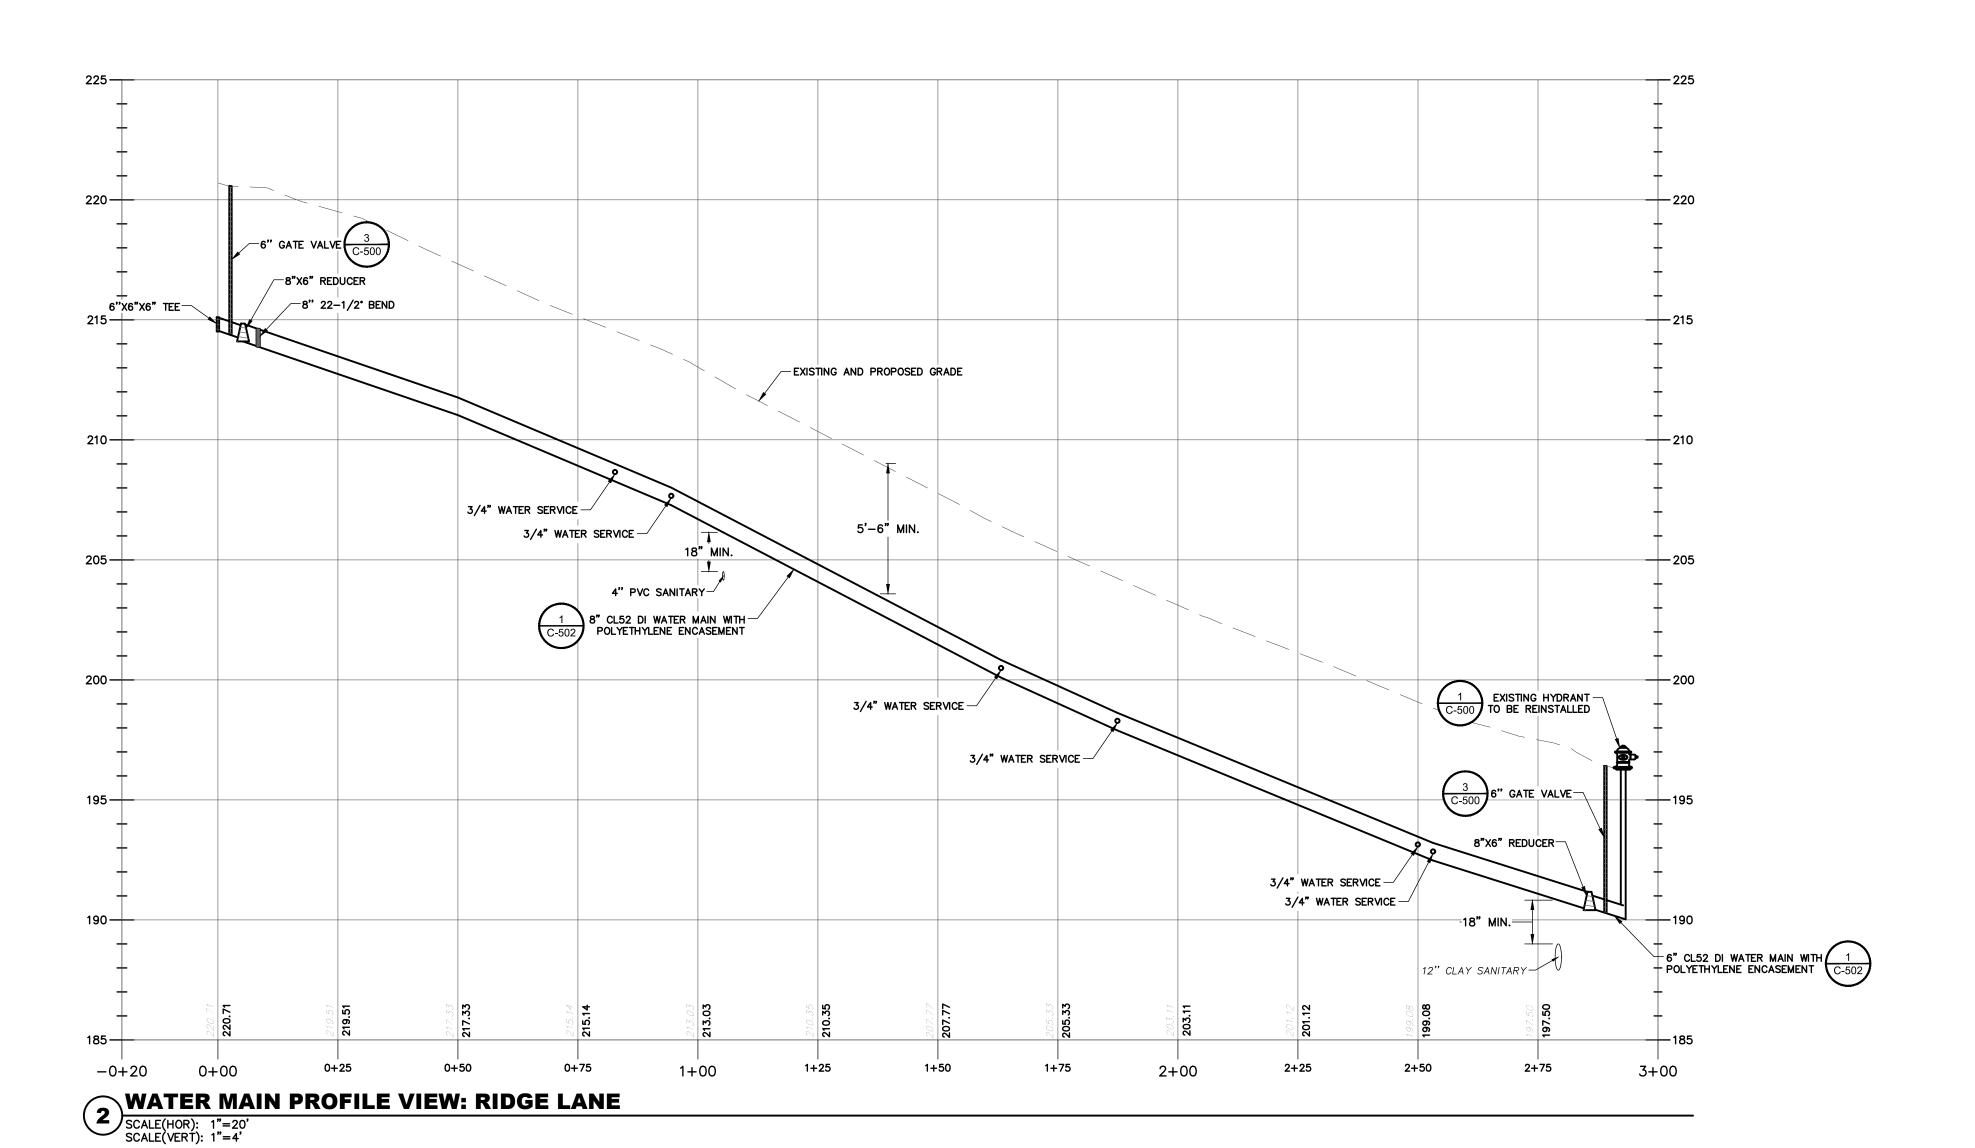

NOTES:

- 1. CONTRACTOR TO VERIFY SIZE AND LOCATION OF EXISTING WATER SERVICES PRIOR TO RECONNECTION.
- CONDUCT EXPLORATORY TEST PITS AT ALL UTILITY CROSSINGS TO DETERMINE LOCATION AND DEPTH OF EXISTING UTILITIES. IN THE EVENT UTILITIES ARE NOT AT THE VERTICAL DEPTHS SHOWN, IMMEDIATELY NOTIFY THE ENGINEER FOR ADJUSTMENT OF THE PIPING VERTICAL ALIGNMENT.
- ALL NEW WATER MAIN PIPING SHALL BE CL52 DUCTILE IRON PIPE, UNLESS OTHERWISE NOTED.
- 4. ALL DUCTILE IRON FITTINGS, PIPING, VALVES AND APPURTENANCES SHALL BE WRAPPED WITH POLYETHYLENE ENCASEMENT. POLYETHYLENE ENCASEMENT ON EXISTING DUCTILE IRON WATER MAINS SHALL BE REPAIRED AFTER CONNECTION IS MADE.
- 5. CONTRACTOR SHALL COORDINATE ALL CONNECTIONS TO EXISTING WATER MAINS AND SERVICES WITH THE TOWN. CONTRACTOR SHALL NOTIFY TOWN NO LESS THAN ONE WEEK PRIOR TO TEMPORARY SHUTDOWN OF WATER MAINS AND SERVICES.
- 6. WATER SERVICE AND SHUT OFF LOCATIONS SHOWN ON THE DRAWINGS ARE APPROXIMATE AND FOR ESTIMATING PURPOSES ONLY. CONTRACTOR SHALL COORDINATE EXACT LOCATION WITH HOMEOWNER, ENGINEER AND TOWN.
- 7. EXISTING WATER SERVICES SHALL BE REPLACED AS FOLLOWS:
- A. EXISTING WATER SERVICES SHALL BE REPLACED FROM NEW WATER MAIN TO PROPERTY LINE. PROVIDE NEW 3/4" TYPE K COPPER SERVICE LINES EXTENDING FROM NEW WATER MAIN TO THE PROPERTY LINE. INSTALL NEW CURB STOPS AND CURB BOXES WITH STAINLESS STEEL RODS AT THE PROPERTY LINE. REMOVE AND DISPOSE OF EXISTING PIPING AND CURB BOX. IF EXISTING SERVICE IS DIFFERENT THAN 3/4", MATCH EXISTING SERVICE SIZE. IN LOCATIONS WHERE THE EXISTING CURB STOP IS BEYOND THE R.O.W., CONTRACTOR SHALL EXTEND NEW SERVICE FROM CURB STOP AT PROPERTY LINE TO CONNECT TO EXISTING SERVICE. PROVIDE NECESSARY COUPLINGS/ADAPTERS TO CONNECT TO EXISTING SERVICE.
- B. ADD ALTERNATE NO. 1: EXISTING LEAD OR GALVANIZED WATER SERVICES SHALL BE REPLACED FROM NEW CURB STOP TO HOUSE. PROVIDE NEW 3/4" TYPE K COPPER SERVICE LINES EXTENDING FROM NEW CURB STOP TO THE HOUSE. PROVIDE NECESSARY COUPLINGS/ADAPTERS TO CONNECT TO EXISTING SERVICE AT HOUSE. CONNECTION TO EXISTING WATER SERVICE SHALL BE MADE 2' OUTSIDE BUILDING FOUNDATION. NO WORK SHALL BE CONDUCTED INSIDE BUILDING.
- 8. ALL NEW WATER MAIN PIPING, INCLUDING SERVICE LINES, SHALL BE TESTED AND DISINFECTED IN ACCORDANCE WITH SECTION 330500.

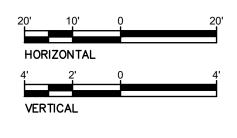

SCALE: 1"=20'

CONTRACT No.: -

DATE: 12/18/19

MJ PROJ. No.: 1075.03

		SUBMITTAL / REVISIONS						JE OF NEW P	
No.	DATE	DESCRIPTION	BY	REVIEWED BY:	DATE	PROJ. MANAGER:	CLD	S S D TAY	
1	12/18/19	BID DOCUMENTS	MLB	C. DOOLEY		CHIEF DESIGNER	MLB		
						DESIGNED BY:	MLB		
						DRAWN BY:	MLB	\\\\\\\\\\\\\\\\\\\\\\\\\\\\\\\\\\\\\\	
						CHECKED BY:	CLD	O COLLSION	
								POPEGGIONE	
								JESSIO!	
								DATE	DATE


THE ALTERATION OF THIS MATERIAL IN ANY WAY, UNLESS DONE UNDER THE DIRECTION OF A COMPARABLE PROFESSIONAL, (I.E.) ARCHITECT FOR AN ARCHITECT, ENGINEER FOR AN ENGINEER OR LAND SURVEYOR FOR A LAND SURVEYOR, IS A VIOLATION OF THE NEW YORK STATE EDUCATION LAW AND/OR REGULATIONS AND IS A CLASS "A" MISDEMEANOR.



TOWN OF MORIAH

WATER MAIN PLAN AND PROFILE: RIDGE LANE

WATER AND SEWER UPGRADES
ESSEX COUNTY NEW YORK

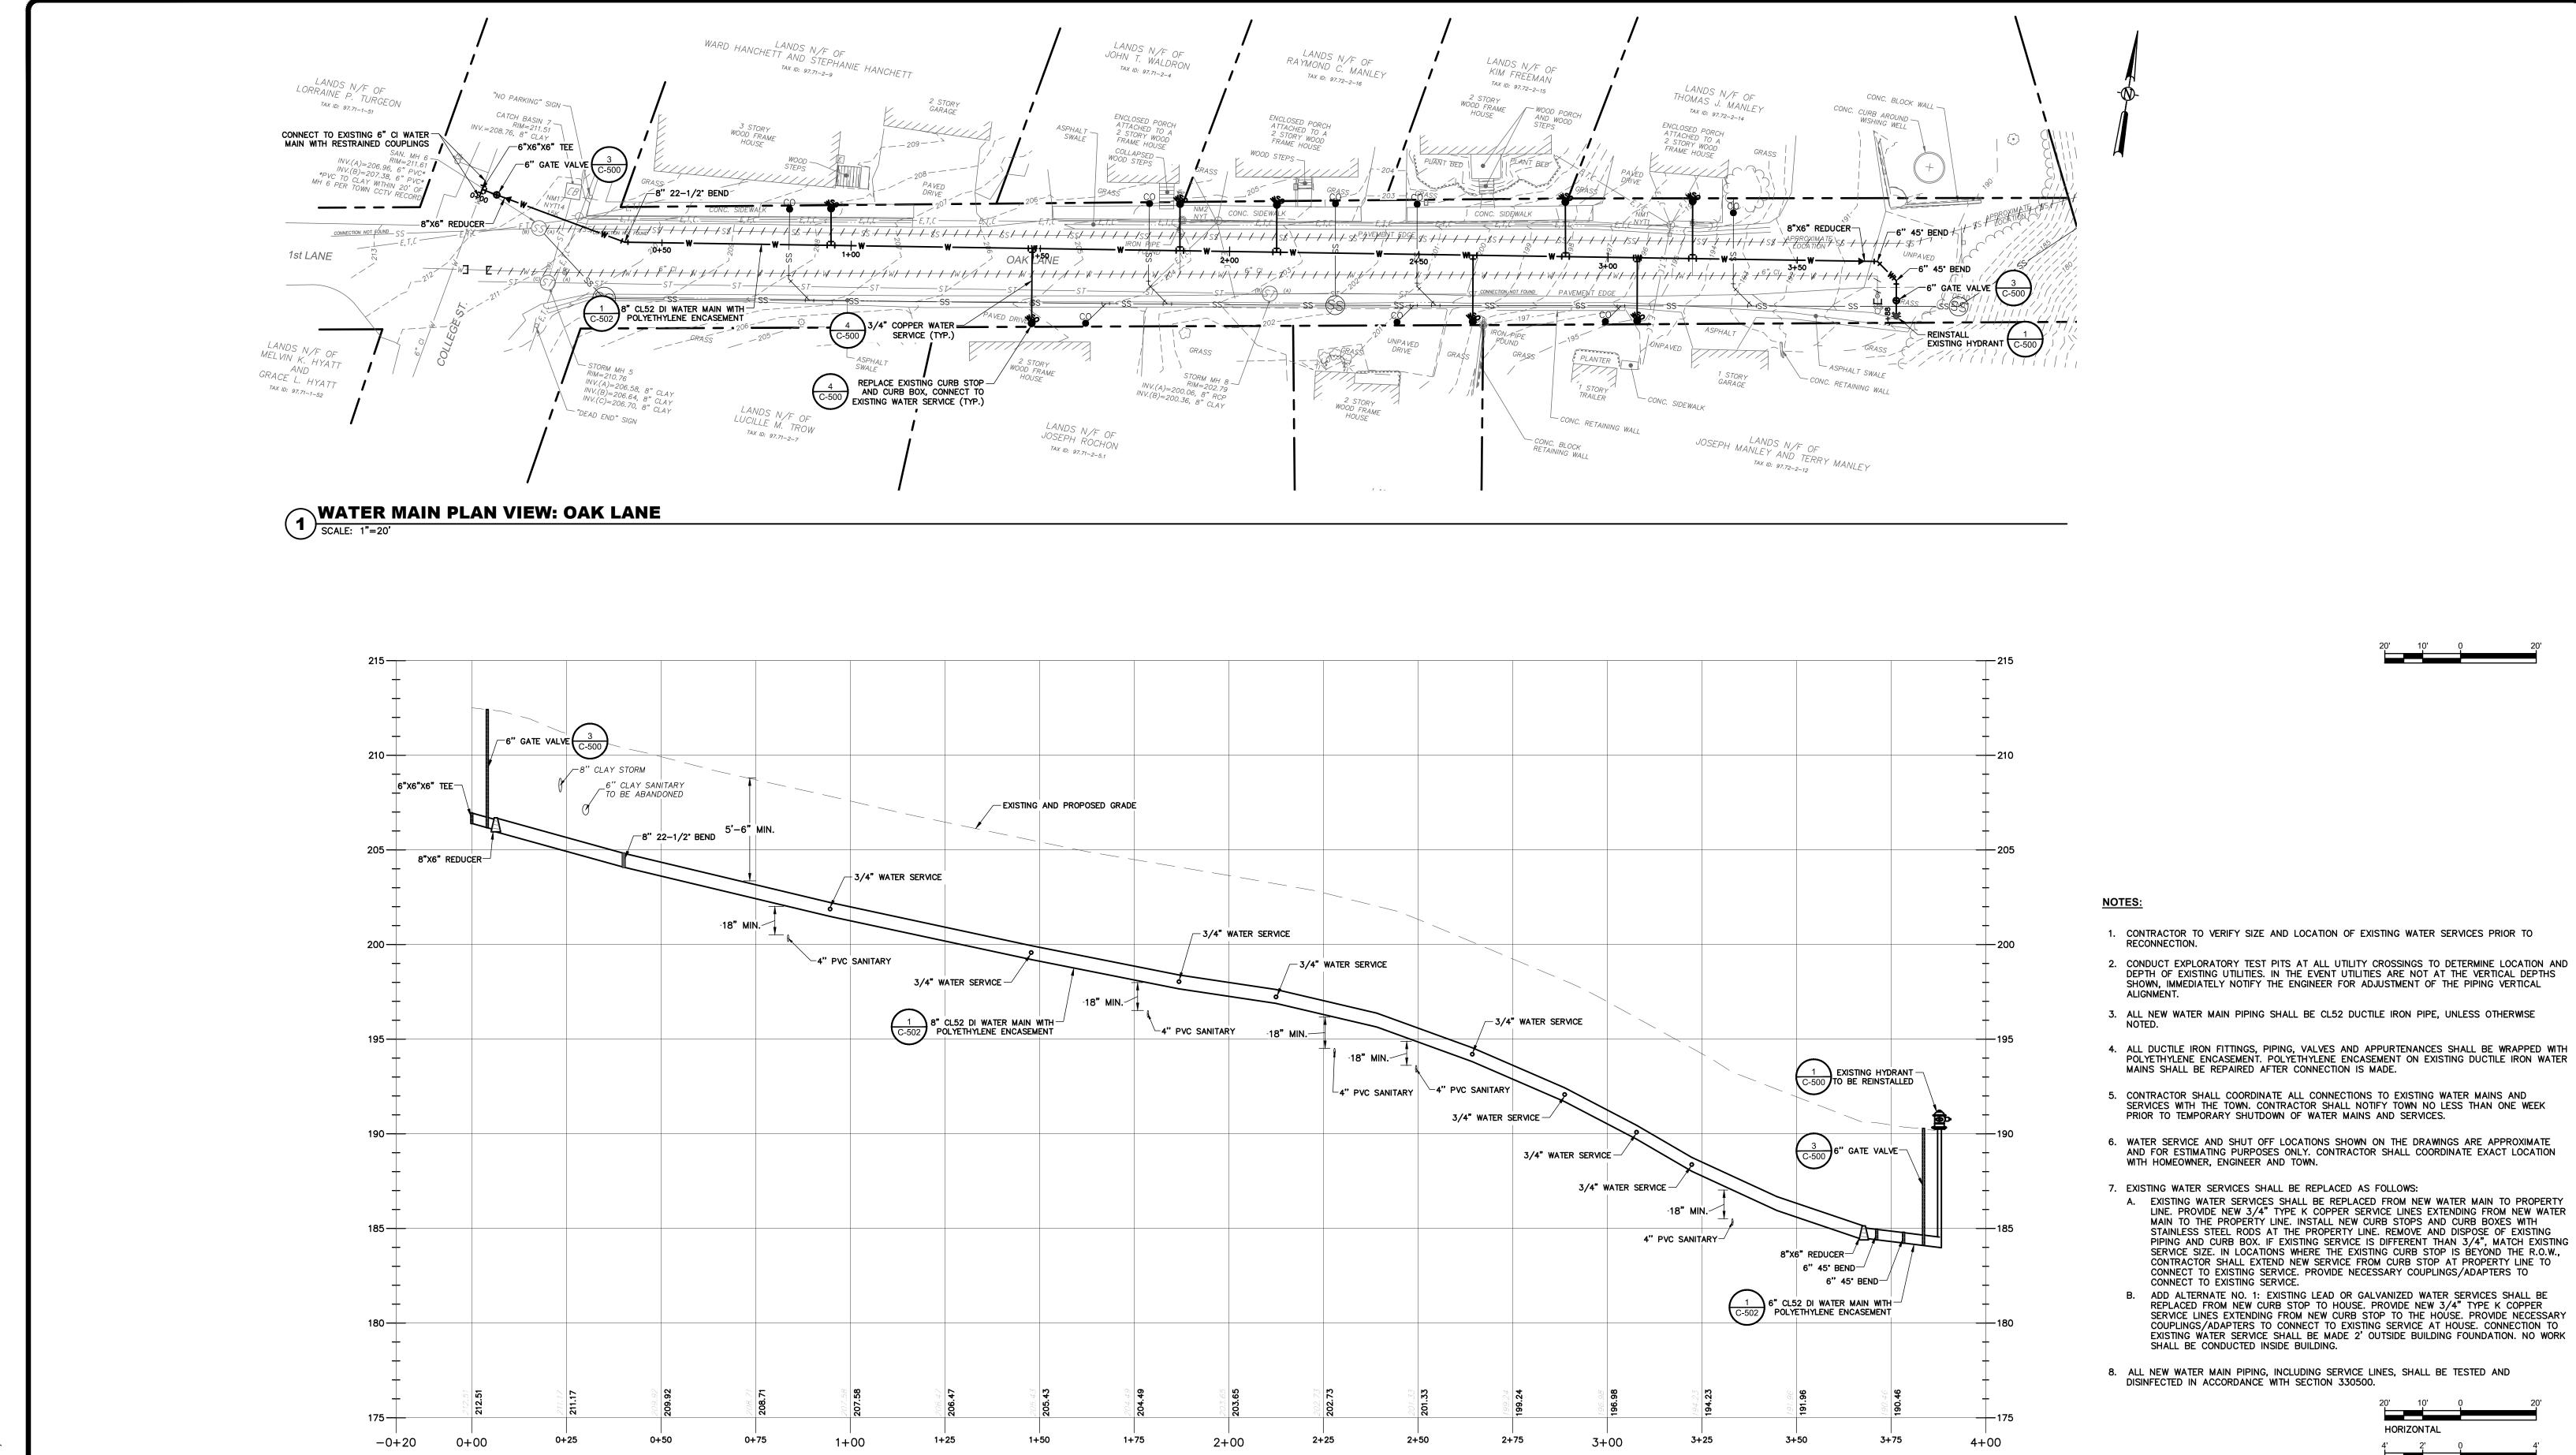

SUBMITTAL / REVISIONS DATE DESCRIPTION BY REVIEWED BY: DATE PROJ. MANAGER: CLE MLB C. DOOLEY 12/18/19 BID DOCUMENTS CHIEF DESIGNER: MLE DESIGNED BY: DRAWN BY: CHECKED BY: OFESSIO! DATE

WATER MAIN PROFILE VIEW: OAK LANE

SCALE(HOR): 1"=20'
SCALE(VERT): 1"=4'

THE ALTERATION OF THIS MATERIAL IN ANY WAY, UNLESS DONE UNDER THE DIRECTION OF A COMPARABLE PROFESSIONAL, (I.E.) ARCHITECT FOR AN ARCHITECT, ENGINEER FOR AN ENGINEER OR LAND SURVEYOR FOR A LAND SURVEYOR, IS A VIOLATION OF THE NEW YORK STATE EDUCATION LAW AND/OR REGULATIONS AND IS A CLASS "A" MISDEMEANOR.



TOWN OF MORIAH

WATER MAIN PLAN AND


WATER AND SEWER UPGRADES **NEW YORK** ESSEX COUNTY

C-201

CONTRACT No.: -MJ PROJ. No.: 1075.03

DATE: 12/18/19


PROFILE: OAK LANE

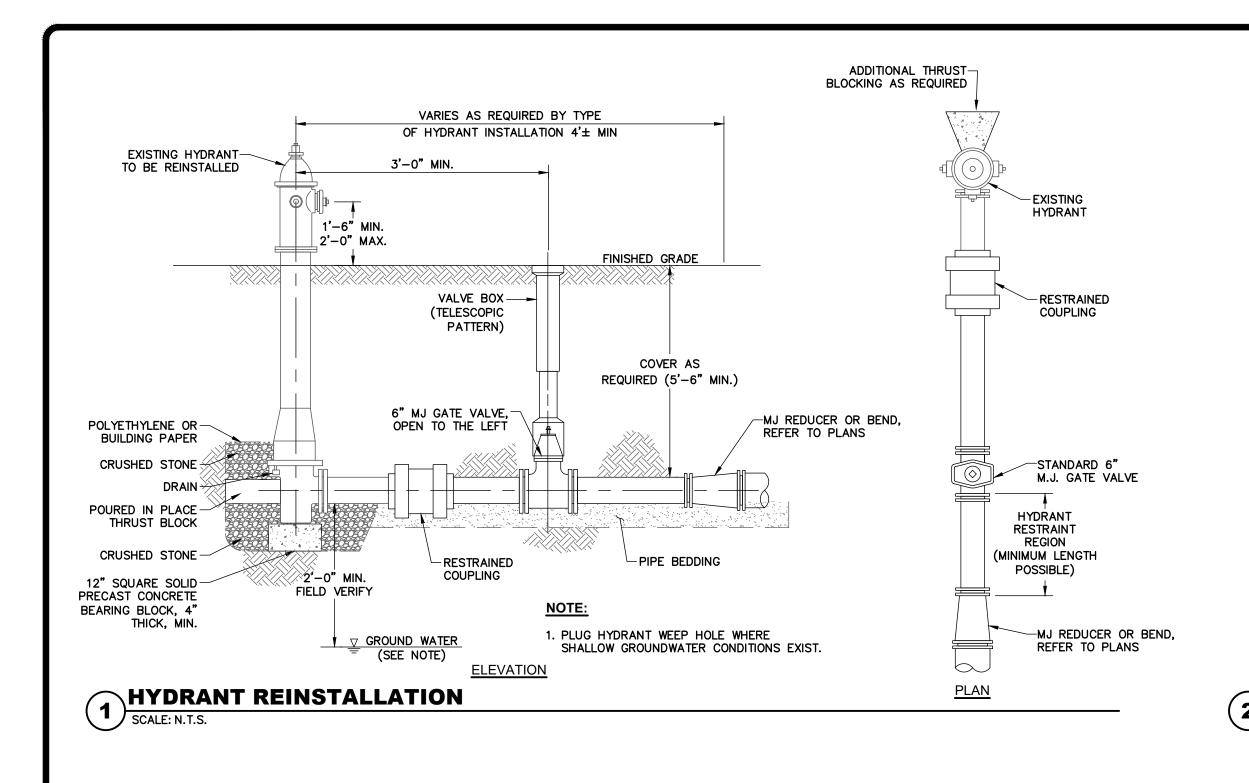

20'-0" (ONE FULL LENGTH) CENTERED (TYP) SANITARY/STORM SEWER (" SANITARY/STORM SEWER (

1. WHEN INSTALLED PARALLEL, ALL WATER AND SANITARY/STORM SEWER LINES SHALL HAVE A MINIMUM SEPARATION OF 10', EDGE TO EDGE. IF MINIMUM CANNOT BE MAINTAINED, WATER MAIN SHALL BE IN SEPARATE TRENCH OR ON AN UNDISTURBED EARTH SHELF TO ONE SIDE OF SANITARY/STORM SEWER, WITH BOTTOM OF WATER MAIN 18" MINIMUM ABOVE TOP OF SEWER PIPE. WHEN CROSSING, MAINS SHALL BE INSTALLED TO INSURE 18" MINIMUM VERTICAL SEPARATION BETWEEN PIPES, OUTSIDE TO OUTSIDE. WHERE WATER MAIN IS UNDERNEATH SEWER, ADEQUATE STRUCTURAL SUPPORT SHALL BE PROVIDED FOR THE SANITARY/STORM SEWER TO PREVENT DAMAGE TO WATER MAIN. WHEN IT IS IMPOSSIBLE TO PROVIDE THE ABOVE MINIMUMS, THE SANITARY/STORM SEWER SHALL BE DESIGNED AND CONSTRUCTED EQUAL TO WATER PIPE, AND SHALL BE PRÉSSURE TESTED TO ASSURE WATER TIGHTNESS PRIOR TO BACKFILLING.


UTILITY SEPARATION REQUIREMENTS

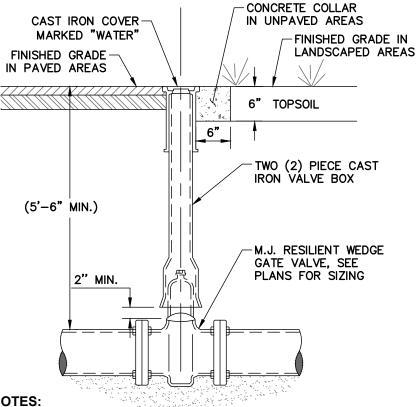


- 1. WATER VALVES SHALL HAVE THEIR INTERIOR AND EXTERIOR SURFACES FUSION EPOXY COATED CONFORMING TO AWWA C550-81. WATER VALVES SHALL BE MECHANICAL JOINT, NON-RISING STEM RESILIENT WEDGE GATE VALVES.
- 2. WATER VALVES SHALL OPEN TO THE LEFT (COUNTERCLOCKWISE) WITH A 2-INCH OPERATING NUT AND HAVE STAINLESS STEEL HARDWARE.
- 3. MINIMUM DISTANCE TO JOINTS, FITTINGS, OR OTHER WET TAPS OR STOPS SHALL BE 3-FEET.


4. MAKE AND MODEL OF GATE VALVE AND VALVE BOX SHALL BE IN

ACCORDANCE WITH PROJECT SPECIFICATIONS. SEE SECTION 331100. TYPICAL UNDERGROUND GATE VALVE
SCALE: N.T.S.

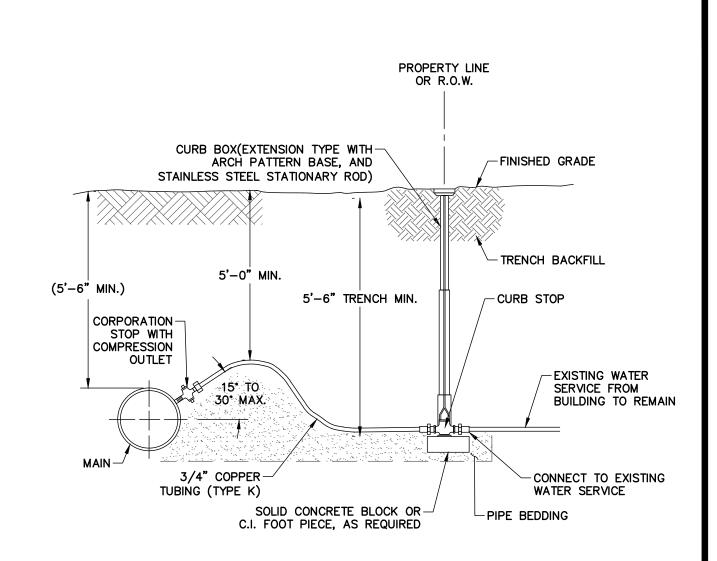

WATER SERVICE SCALE: N.T.S.

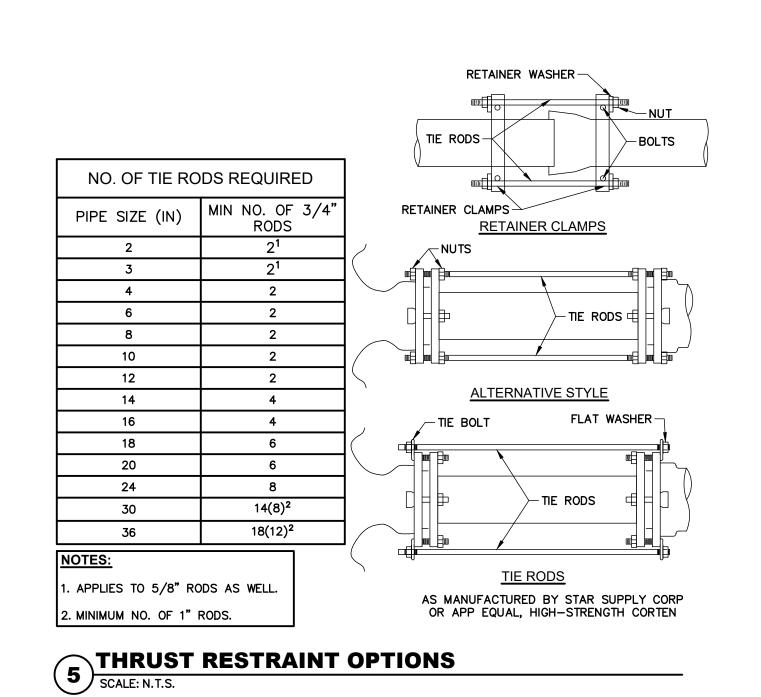

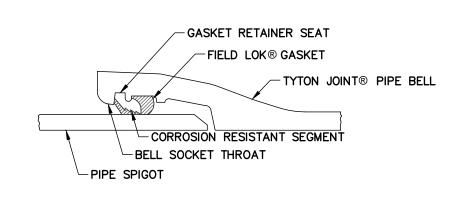


NOTES:

- 1. ALL UNDERGROUND DUCTILE IRON PIPE JOINTS SHALL BE RESTRAINED WITH FIELD LOK®
- 2. PROVIDE TWO BRONZE WEDGES AT EACH JOINT TO MAINTAIN ELECTRICAL CONDUCTIVITY.

DATE

RESTRAINED JOINT (6) SCALE: N.T.S.

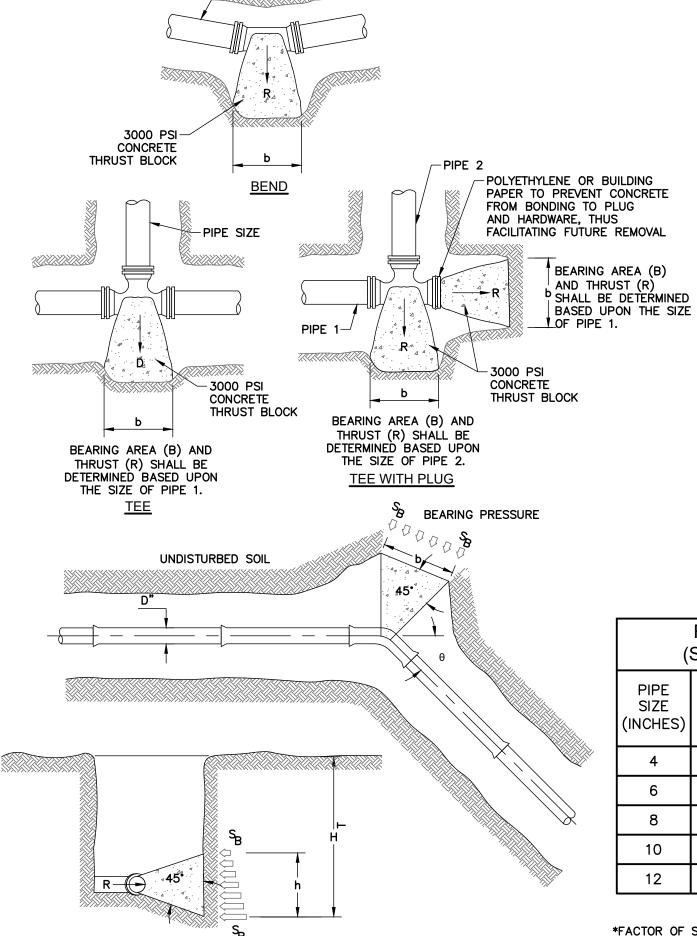

- 1. THRUST BLOCKS SHALL BE USED FOR ALL MECHANICAL JOINT TEES AND FIELD BENDS. MECHANICAL JOINT RESTRAINT SHALL BE PROVIDED AT ALL UNDERGROUND FITTINGS. ALL UNDERGROUND DUCTILE IRON PUSH-ON PIPE JOINTS SHALL BE RESTRAINED WITH FIELD LOK® GASKETS, OR EQUAL.
- 2. CONCRETE SHALL NOT OVERLAP ANY JOINT.
- 3. THRUST BLOCKS SHALL BE CONFIGURED IN A MANNER THAT DOES NOT INTERFERE WITH REMOVAL OR INSTALLATION OF ANY JOINTING
- 4. BEARING SURFACE SHALL, WHERE POSSIBLE, BE PLACED AGAINST UNDISTURBED SOIL. WHERE THAT IS NOT POSSIBLE, THE FILL BETWEEN THE BEARING SURFACE AND UNDISTURBED SOIL MUST BE COMPACTED TO AT LEAST 90% STANDARD PROCTOR DENSITY.
- 5. BLOCK HEIGHT (h) SHALL BE EQUAL TO OR LESS THAN ONE-HALF THE TOTAL DEPTH TO THE BOTTOM OF THE BLOCK, (HT), BUT NOT LESS THAN THE PIPE DIAMETER (D).
- 6. BLOCK HEIGHT (h) SHALL BE ESTABLISHED SUCH THAT THE CALCULATED BLOCK WIDTH (b) VARIES BETWEEN ONE AND TWO TIMES THE
- 7. VALUES FOR TEES APPLY TO TEES, END PLUGS, CAPS, AND TAPPING SLEEVES.

ARING	SOIL	S (LB/SQ FT)
RENGTH	MUCK	0
	SOFT CLAY	1,000
	SILT	1,500
	SANDY SILT	3,000
	SAND	4,000
	SANDY CLAY	6,000
	HARD CLAY	9,000

- 8. REQUIRED BEARING AREAS ARE DEVELOPED TO RESIST THRUSTS RESULTING FROM 150 PSI WORKING PRESSURE PLUS 50%(75 PSI) SURGE ALLOWANCE RESULTING IN 225 PSI TOTAL INTERNAL PRESSURE. REQUIRED BEARING AREAS ARE BASED UPON AN ÀLLOWABLE SOIL BEARING CAPACITY OF 3,000 POUNDS PER SQUARE FOOT. IN RESPONSE TO OTHER SOIL CONDITIONS ENCOUNTERED, BEARING AREAS REQUIRED MAY BE MODIFIED BY THE ENGINEER.IN MUCK, PEAT, OR RECENTLY PLACED FILL, ALL THRUSTS SHALL BE RESISTED BY PILES OR TIE RODS TO SOLID FOUNDATIONS, OR BY REMOVAL OF SUCH UNSTABLE MATERIAL AND REPLACEMENT WITH BALLAST OF SUFFICIENT STABILITY TO RESIST THE THRUSTS; ALL AS REQUIRED BY THE ENGINEER.
- 9. CONCRETE THRUST BLOCK SHALL BE USED ONLY AS ALLOWED BY THE PROJECT PLANS AND/OR SPECIFICATION. WHERE RESTRAINED JOINT PIPE IS TO BE USED SEE MANUFACTURER'S SPECIFICATIONS AND INSTALLATION REQUIREMENTS.

REQUIRED BEARING AREAS -b (SQ. FT.) FOR BEARING BLOCKS*							
PIPE SIZE (INCHES)	TEE	90° BEND	45° BEND	22-1/2° BEND	11–1/4° BEND		
4	2.0	2.8	1.5	0.8	0.4		
6	4.2	5.9	3.2	1.6	0.8		
8	7.2	10.1	5.5	2.8	1.4		
10	10.9	15.4	8.3	4.2	2.1		
12	15.4	21.8	11.8	6.0	3.0		

THRUST REACTIONS-R(LB) PER 100PSI INTERNAL PRESSURE								
NOM. PIPE DIA (IN)	DEAD END	90° BEND	45° BEND	22-1/2° BEND	11-1/4° BEND			
4	1,810	2559	1385	706	355			
6	3,739	5,288	2,862	1,459	733			
8	6,433	9,097	4,923	2510	1,261			
10	9,677	13,685	7,406	3,776	1,897			
12	13,685	19,353	10,474	5,340	2,683			

*FACTOR OF SAFETY=1.5 SOIL BEARING OF 3,000 PSF 225 PSI DESIGN PRESSURE *BEARING AREA (B) = bxh

en		SUBMITTAL / REVISIONS					JE OF NEW P
No.	DATE	DESCRIPTION	BY	REVIEWED BY:	DATE	PROJ. MANAGER: CLD	
1	12/18/19	BID DOCUMENTS	MLB	C. DOOLEY		CHIEF DESIGNER: MLB	
						DESIGNED BY: MLB	
						DRAWN BY: MLB	\\Z\\Z\\Z\\Z\\Z\\Z\\Z\\Z\\\Z\\Z\\\Z\\\
						CHECKED BY: CLD	Treets 10th
							POFFS310NP
			$\overline{}$				V OF ECCI () V

THE ALTERATION OF THIS MATERIAL IN ANY WAY, UNLESS DONE UNDER THE DIRECTION OF A COMPARABLE PROFESSIONAL, (I.E.) ARCHITECT FOR AN ARCHITECT, ENGINEER FOR AN ENGINEER OR LAND SURVEYOR FOR A LAND SURVEYOR, IS A VIOLATION OF THE NEW YORK STATE EDUCATION LAW AND/OR REGULATIONS AND IS A CLASS "A" MISDEMEANOR.

7 THRUST BLOCK
SCALE: N.T.S.



TOWN OF MORIAH

WATER DETAILS


WATER AND SEWER UPGRADES **NEW YORK** ESSEX COUNTY

C-500

SCALE: N.T.S

CONTRACT No.: -MJ PROJ. No.: 1075.03

DATE: 12/18/19

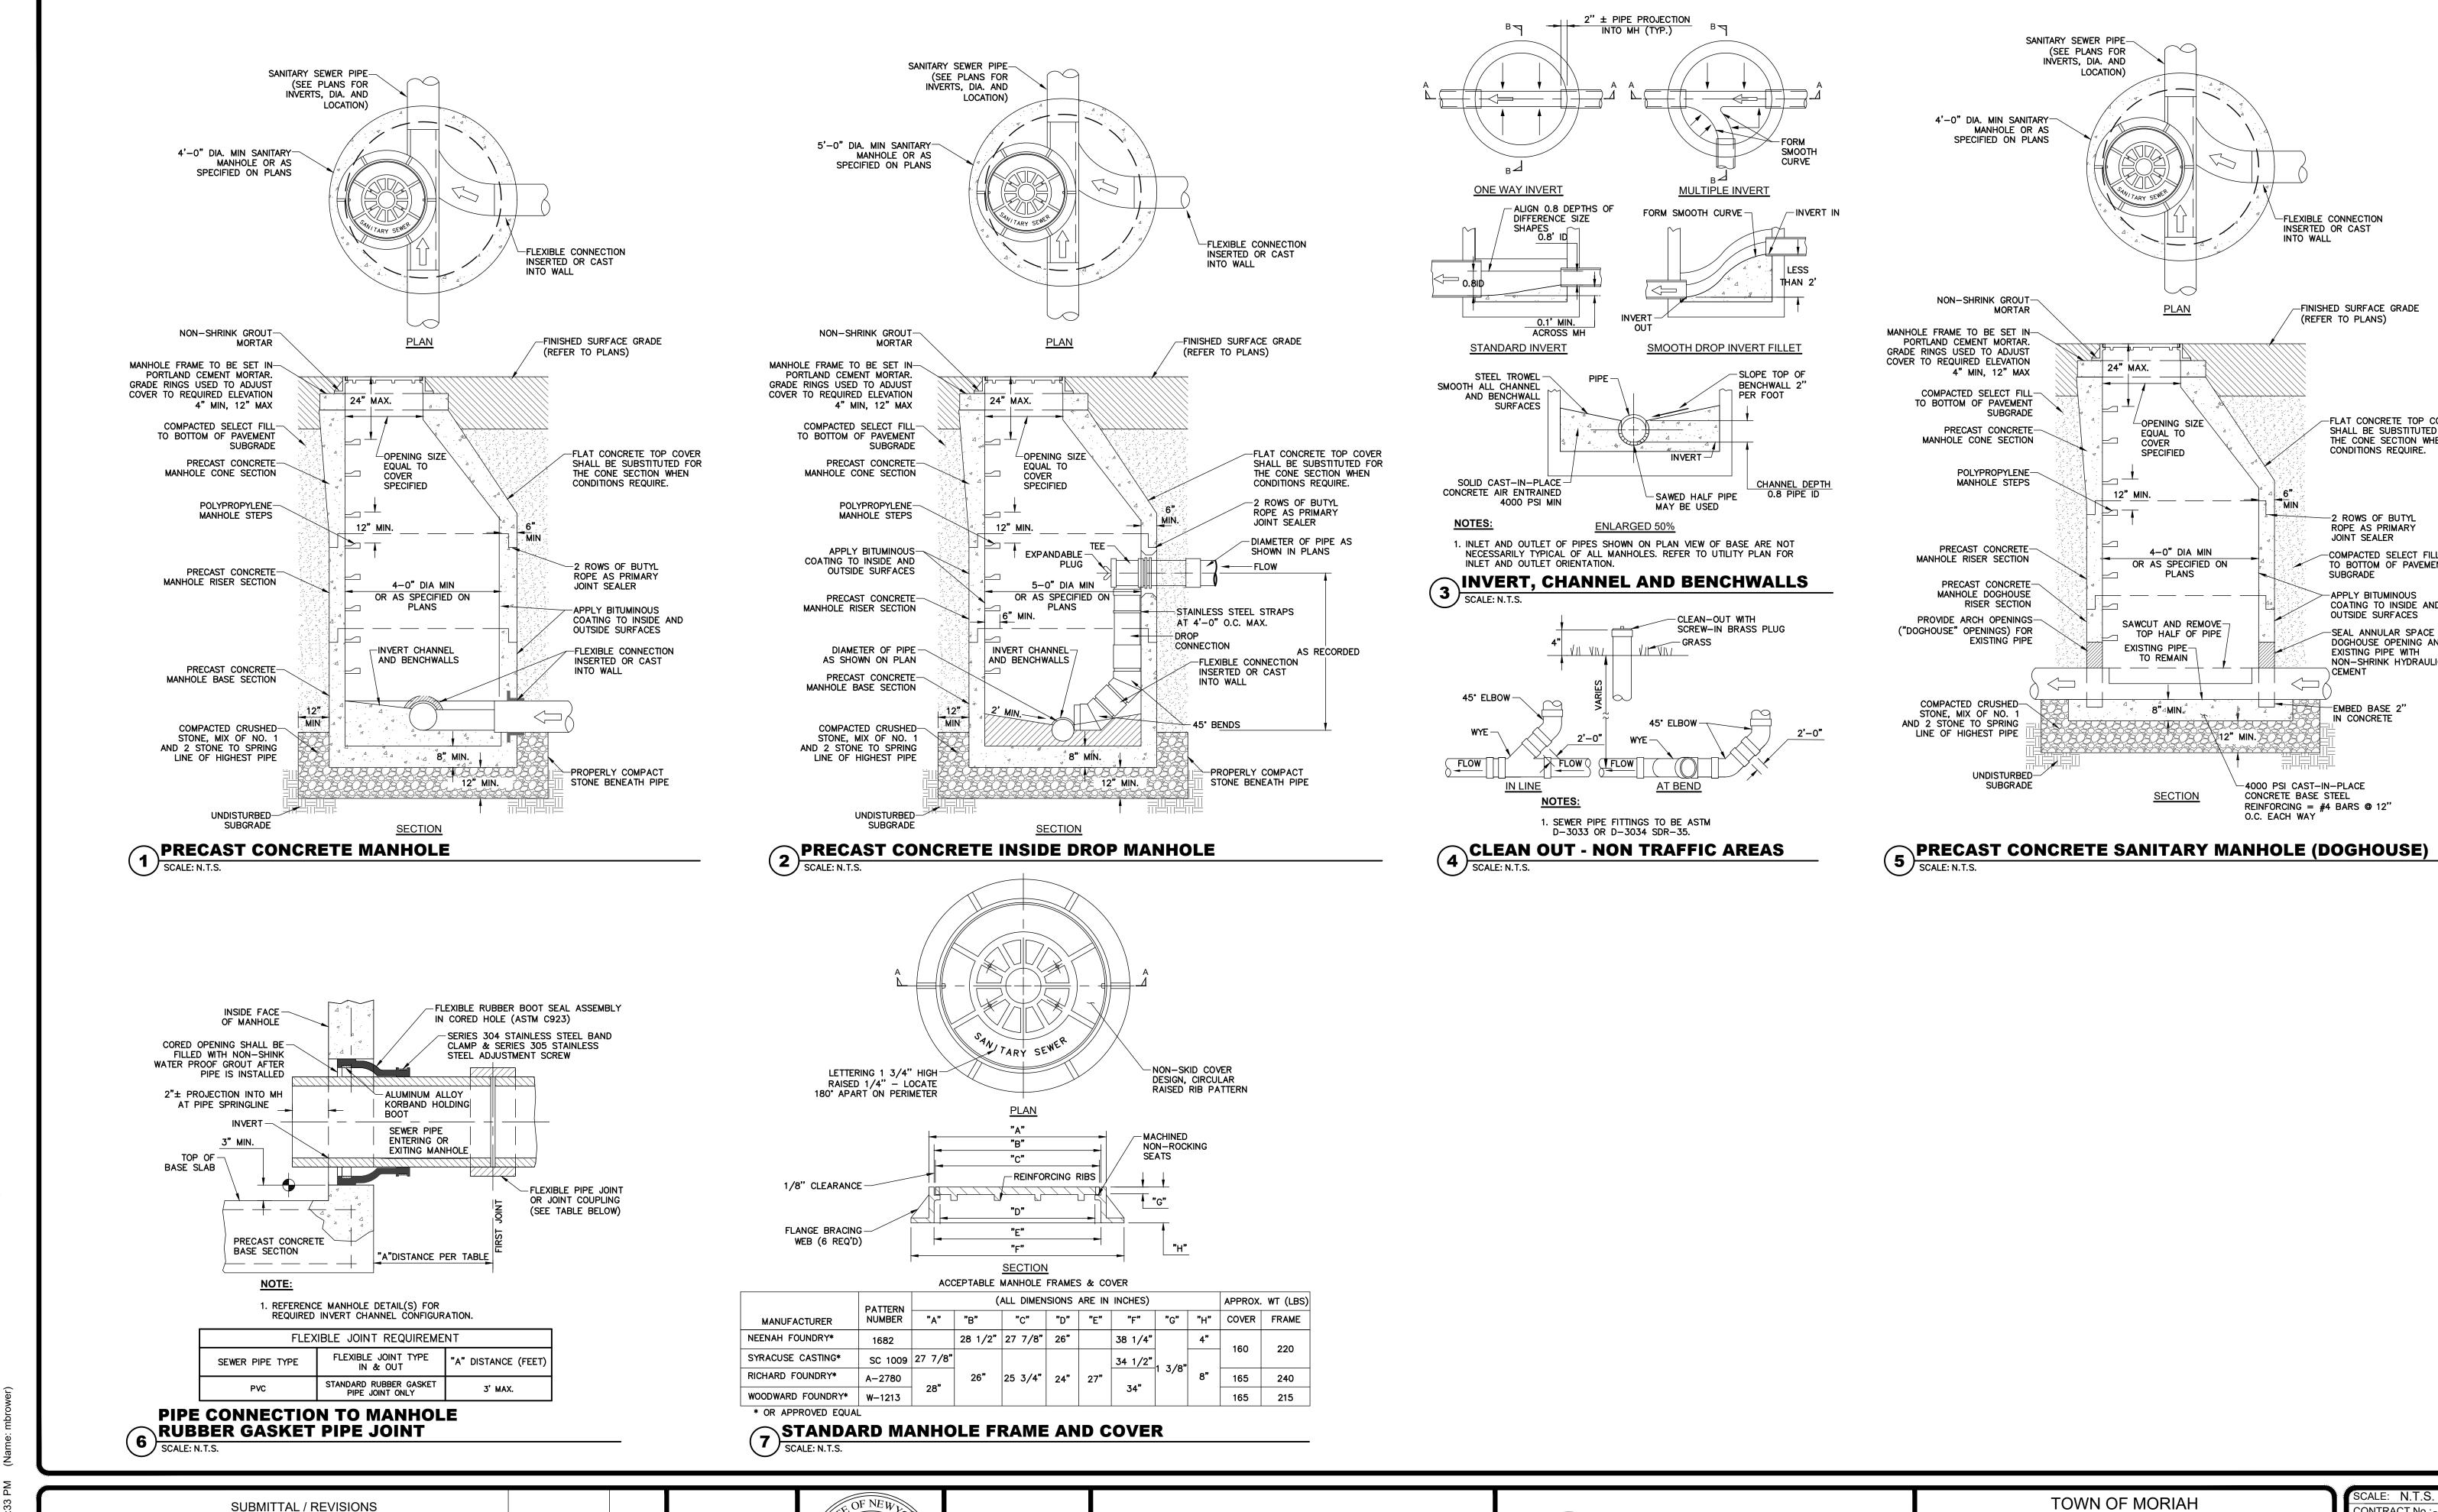

SCALE: N.T.S. CONTRACT No.:-MJ PROJ. No.: 1075.03 DATE: 12/18/19

Engineering and Land Surveying, P.C. 1533 Crescent Road - Clifton Park, NY 12065

THE ALTERATION OF THIS MATERIAL IN ANY WAY, UNLESS DONE UNDER THE DIRECTION OF A COMPARABLE PROFESSIONAL, (I.E.) ARCHITECT FOR AN ARCHITECT, ENGINEER FOR AN ENGINEER OR LAND SURVEYOR FOR A LAND SURVEYOR, IS A VIOLATION OF THE NEW YORK STATE EDUCATION LAW AND/OR REGULATIONS AND IS A CLASS "A" MISDEMEANOR.

ROFESSION DATE

SUBMITTAL / REVISIONS

DESCRIPTION

12/18/19 BID DOCUMENTS

BY REVIEWED BY:

MLB C. DOOLEY

DATE

PROJ. MANAGER: CLE

DESIGNED BY:

DRAWN BY:

CHECKED BY:

CHIEF DESIGNER: MLB

WATER AND SEWER UPGRADES **NEW YORK**

SANITARY SEWER

DETAILS

ESSEX COUNTY

C-501

-FLEXIBLE CONNECTION INSERTED OR CAST

FINISHED SURFACE GRADE

FLAT CONCRETE TOP COVER SHALL BE SUBSTITUTED FOR

THE CONE SECTION WHEN

CONDITIONS REQUIRE.

-2 ROWS OF BUTYL ROPE AS PRIMARY

-COMPACTED SELECT FILL

TO BOTTOM OF PAVEMENT

-APPLY BITUMINOUS COATING TO INSIDE AND

DOGHOUSE OPENING AND

EXISTING PIPE WITH NON-SHRINK HYDRAULIC

SEAL ANNULAR SPACE BETWEEN

OUTSIDE SURFACES

JOINT SEALER

SUBGRADE


CEMENT

-EMBED BASE 2"

IN CONCRETE


(REFER TO PLANS)

INTO WALL

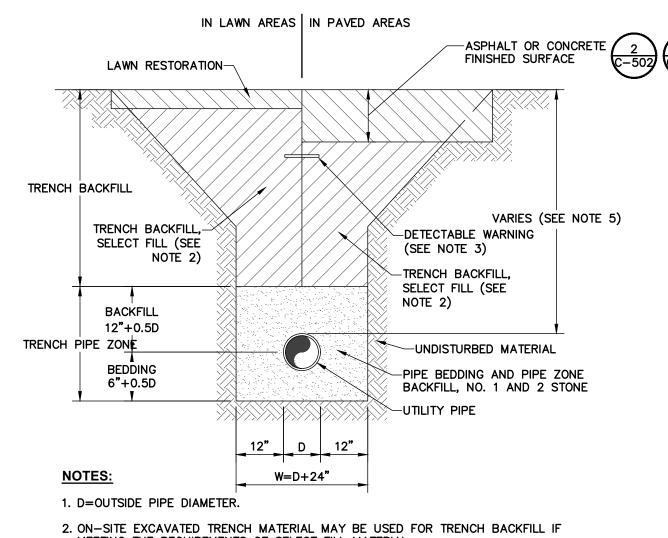

- MEETING THE REQUIREMENTS OF SELECT FILL MATERIAL.
- 3. PLACE DETECTABLE WARNING TAPE 6" BELOW SUBBASE IN PAVED AREAS AND 12" BELOW FINISHED GRADE IN LAWN OR LANDSCAPING AREAS.
- 4. TRENCHING SHALL BE IMPLEMENTED IN ACCORDANCE WITH O.S.H.A. STANDARDS.
- 5. THE MINIMUM DEPTH TO TOP OF UTILITY PIPE SHALL BE:
- POTABLE WATER: 5'-6" SANITARY SEWER: 4'-0"
- 6. REFER TO SPECIFICATION SECTION 312333 FOR TRENCH BACKFILL, PIPE BEDDING AND PIPE ZONE BACKFILL GRADATION AND COMPACTION REQUIREMENTS.



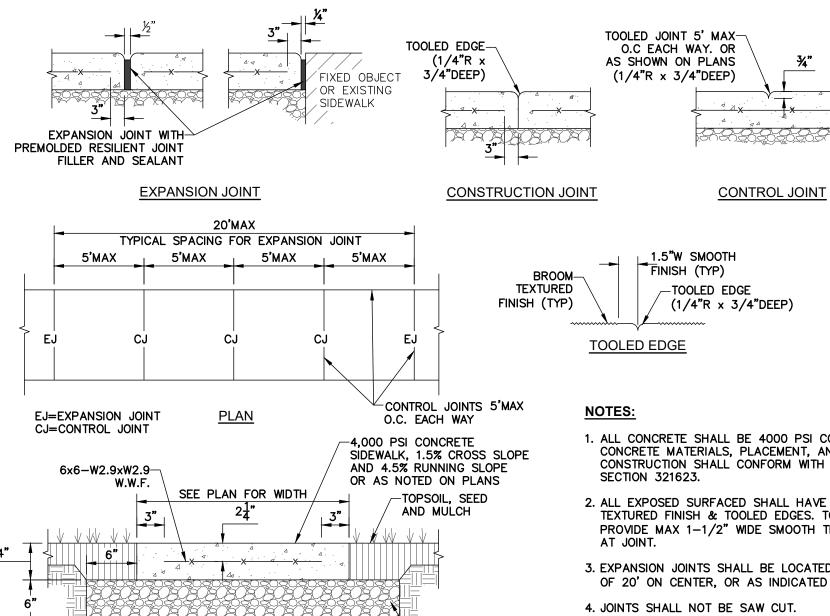

-SUBBASE COURSE

-36" MIN. FENCE POSTS, DRIVEN

MIN. 16" INTO GROUND

TYPE 2


COMPACTED SELECT GRANULAR

FILL TO BRING SUBGRADE TO

-COMPACTED SUBGRADE OR

CORRECT GRADE.


- 1. ALL CONCRETE SHALL BE 4000 PSI CONCRETE. CONCRETE MATERIALS, PLACEMENT, AND CONSTRUCTION SHALL CONFORM WITH SPECIFICATION
- 2. ALL EXPOSED SURFACED SHALL HAVE A BROOM TEXTURED FINISH & TOOLED EDGES. TOOL SHALL BE PROVIDE MAX 1-1/2" WIDE SMOOTH TROWEL FINISH
- 3. EXPANSION JOINTS SHALL BE LOCATED A MAXIMUM OF 20' ON CENTER, OR AS INDICATED ON PLANS.
- 4. JOINTS SHALL NOT BE SAW CUT.
- 5. SUBBASE MATERIAL SHALL CONFORM WITH SPECIFICATION SECTION 312000.
- 6. WHERE IT IS NECESSARY TO PLACE FILL FOR PURPOSE OF BRINGING THE SUBGRADE ELEVATION UP TO A SPECIFIED GRADE, THE FILL MATERIAL PLACED SHALL BE IN ACCORDANCE WITH SPECIFICATION SECTION 312000.

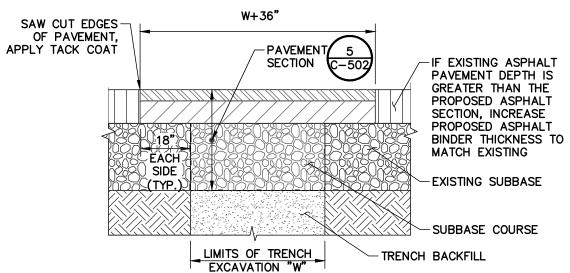

NOTES:

- 1. SAW CUT AS INDICATED, 18" BEYOND EXCAVATION.
- 2. FURNISH, PLACE AND COMPACT SURFACE.
- 3. TACK COAT IN ACCORDANCE WITH NYSDOT STANDARD SPEC.
- 4. FURNISH AND PLACE ASPHALT CONCRETE PAVEMENT AS SPECIFIED.

TRENCH SURFACE RESTORATION IN ASPHALT PAVEMENT (3) SCALE: N.T.S

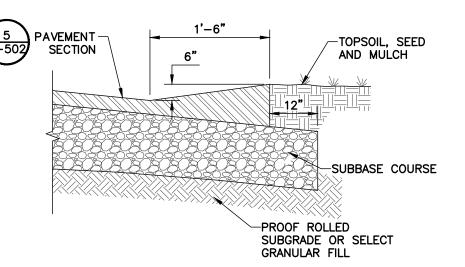

-SOCKS TO BE SECURED AT


-CATCH BASIN

STRUCTURE

OR WIRE ALTERNATIVE

INSTALLATION USING A


ASPHALT WING GUTTER (**4**) SCALE: N.T.S.

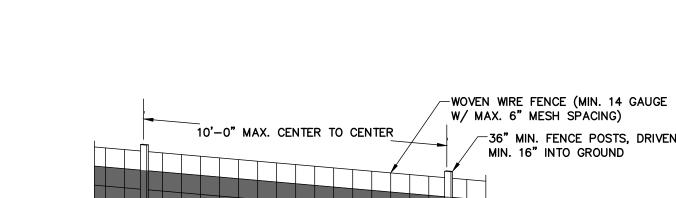

CONCRETE SIDEWALK

(**2**) SCALE: N.T.S.

SECTION

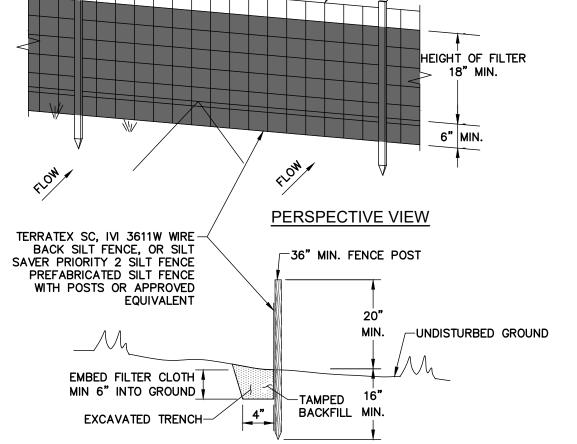


- 1. WOVEN WIRE FENCE TO BE FASTENED SECURELY TO FENCE POSTS WITH WIRE TIES OR STAPLES. POSTS SHALL BE STEEL "T" OR "U" TYPE OR HARDWOOD.
- 2. FILTER CLOTH TO BE FASTENED SECURELY TO WOVEN WIRE FENCE WITH TIES SPACED EVERY 24" AT TOP AND MID SECTION. FENCE SHALL BE WOVEN WIRE, 6" MAX. MESH OPENING.

SECTION

- 3. WHEN TWO SECTIONS OF FILTER CLOTH ADJOIN EACH OTHER THEY SHALL BE OVERLAPPED BY 6" AND FOLDED.
- 4. MAINTENANCE SHALL BE PERFORMED AS NEEDED AND MATERIALS REMOVED WHEN "BULGES" DEVELOP IN THE SILT FENCE.
- 5. MAXIMUM DRAINAGE AREA FOR OVERLAND FLOW TO A SILT FENCE SHALL NOT EXCEED 1/4 ACRE PER 100 FEET OF FENCE. 6. SILT FENCE SHALL BE USED WHERE EROSION COULD OCCUR IN THE FORM OF SHEET EROSION.
- 7. SILT FENCE SHALL NOT BE USED WHEN A CONCENTRATION OF WATER IS FLOWING TO THE BARRIER.


DATE

SILT FENCE INSTALLATION
SCALE: NTS

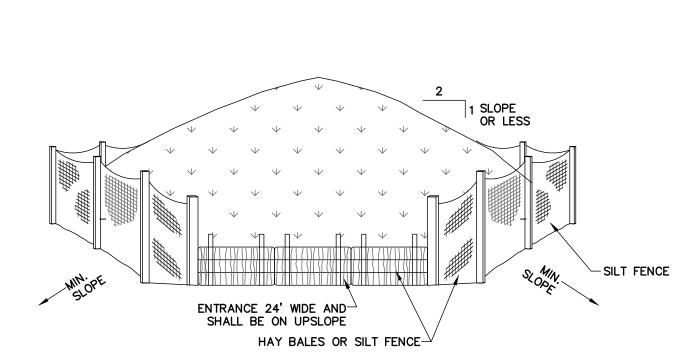

- 1. AREA CHOSEN FOR STOCKPILING OPERATIONS SHALL BE DRY AND STABLE.
- 2. MAXIMUM SLOPE OF STOCKPILE SHALL BE 2 HORIZ ON 1 VERT.
- 3. UPON COMPLETION OF SOIL STOCKPILING, EACH PILE SHALL BE SURROUNDED WITH EITHER SILT FENCING OR HAY BALES, THEN STABILIZED WITH VEGETATION OR COVERED.

TEMPORARY SOIL STOCKPILE SCALE: NTS

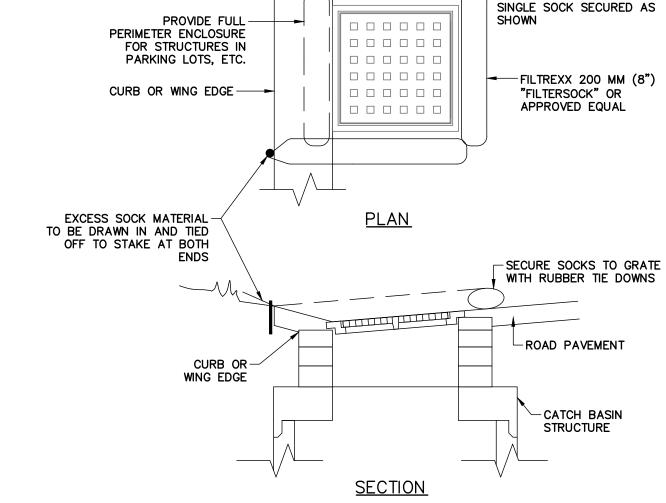

- 1. INSTALLATION TO BE COMPLETED IN ACCORDANCE WITH MANUFACTURER'S SPECIFICATIONS.
- 2. SECURE FILTERSOCK TO GROUND AT BOTH ENDS.
- 3. INLET PROTECTION SHALL REMAIN IN-PLACE UNTIL SITE HAS BEEN STABILIZED.

CATCH BASIN GRATE INLET FILTER
SCALE: NTS

E	ASPHALT PAVEMENT SECTION SCALE: N.T.S.
(3)	SCALE: N.T.S.

REFER TO SPECIFICATION SECTION 321216 FOR PAVEMENT MATERIAL REQUIREMENTS.

1. TACK COAT WHEN SPECIFIED OR CALLED OUT IN THESE DRAWINGS OR WHEN PAVEMENT COURSES ARE

NOT INSTALLED IMMEDIATELY AFTER ONE ANOTHER.

	SUBMITTAL / REVISIONS				
DATE	DESCRIPTION	BY	REVIEWED BY:	DATE	PROJ. MANAGER:
12/18/19	BID DOCUMENTS	MLB	C. DOOLEY		CHIEF DESIGNER
					DESIGNED BY:
					DRAWN BY:
					CHECKED BY:


→ 2" TOP COURSE 12.5 MM

12" SUBBASE TYPE 2


--WOVEN GEOTEXTILE

----3" BINDER COURSE 25.0 MM

-PROOF ROLLED SUBGRADE, OR COMPACTED SELECT GRANULAR FILL

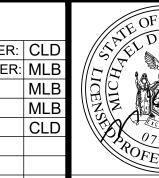

SFESS10

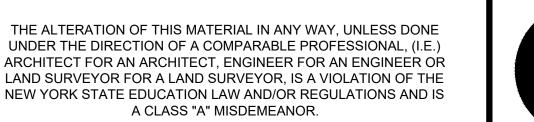



TOWN OF MORIAH

SITE DETAILS

WATER AND SEWER UPGRADES ESSEX COUNTY

C-502

CONTRACT No.: -MJ PROJ. No.: 1075.03 DATE: 12/18/19